

PLANNING AND DEVELOPMENT DEPARTMENT
3RD FLOOR, HDC BUILDING HULHUMALE'
REPUBLIC OF MALDIVES
TEL. +(960)3353535, FAX +(960)3358892
EMAIL : planning@hdc.com.mv

PROJECT: LOT 11057


Drawn by: Razzan

Checked by:

Date: 15 MARCH 2021

DRAWING: LOCATION MAP

Remarks:

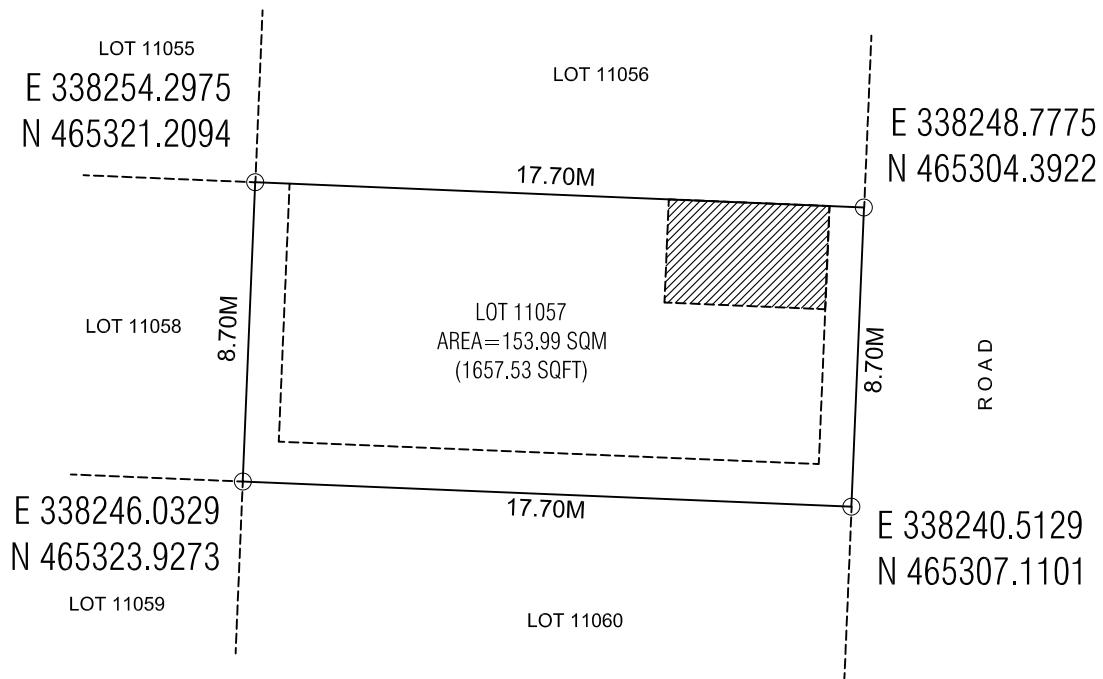

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PROJECT: LOT 11057

Scale: N.T.S


Drawn by: Mauman

Checked by:

Date: 15 March 2021

Remarks:

DRAWING: PLOT MAP

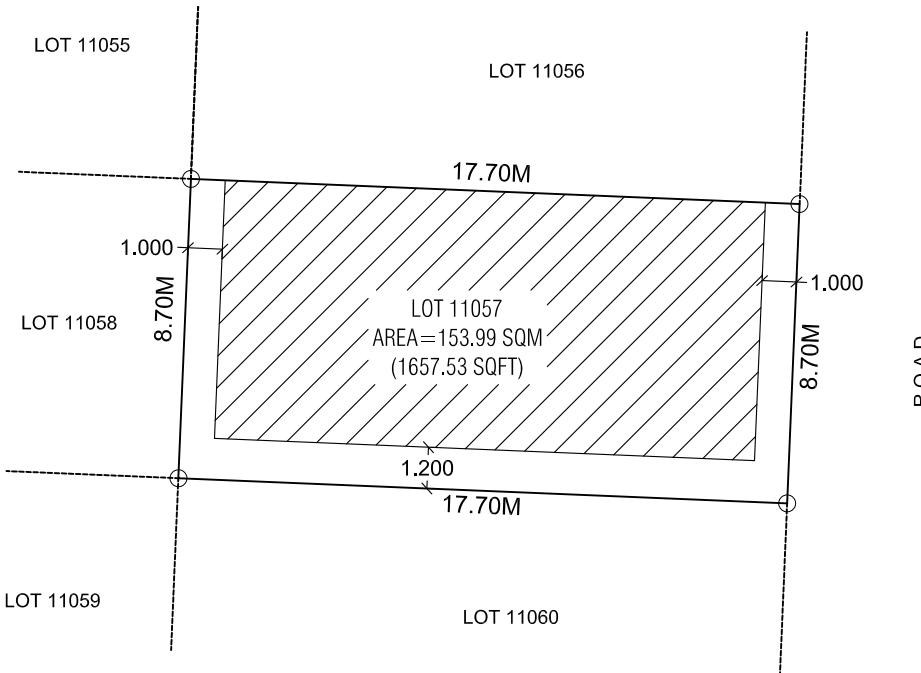

NOTE :

PLEASE NOTE THAT GROUND FLOOR FOR THIS PLOT IS TO BE
DEDICATED ONLY FOR PARKING.

Lot Number	Parcel Number	Description	Land Use	Plot Area	Foot Print	Gross Floor Area (G.F.A)	Plot Ratio (F.S.I)	Site Coverage	Max Height / Floors
11057	N3-5B	Pure Residential	Residential	153.99 SQM 1,657.53 SQFT	117.03 SQM 1,259.73 SQFT	684.64 SQM 7,369.39 SQFT	4.4	76%	6.5 Floors / 19.5 m 19.5 bldg + 4m Lift Machine Room

PROJECT: LOT 11057

Scale: N.T.S

Drawn by: Mauman

Checked by:


Date: 15 March 2021

Remarks:



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DRAWING: SETBACK PLAN

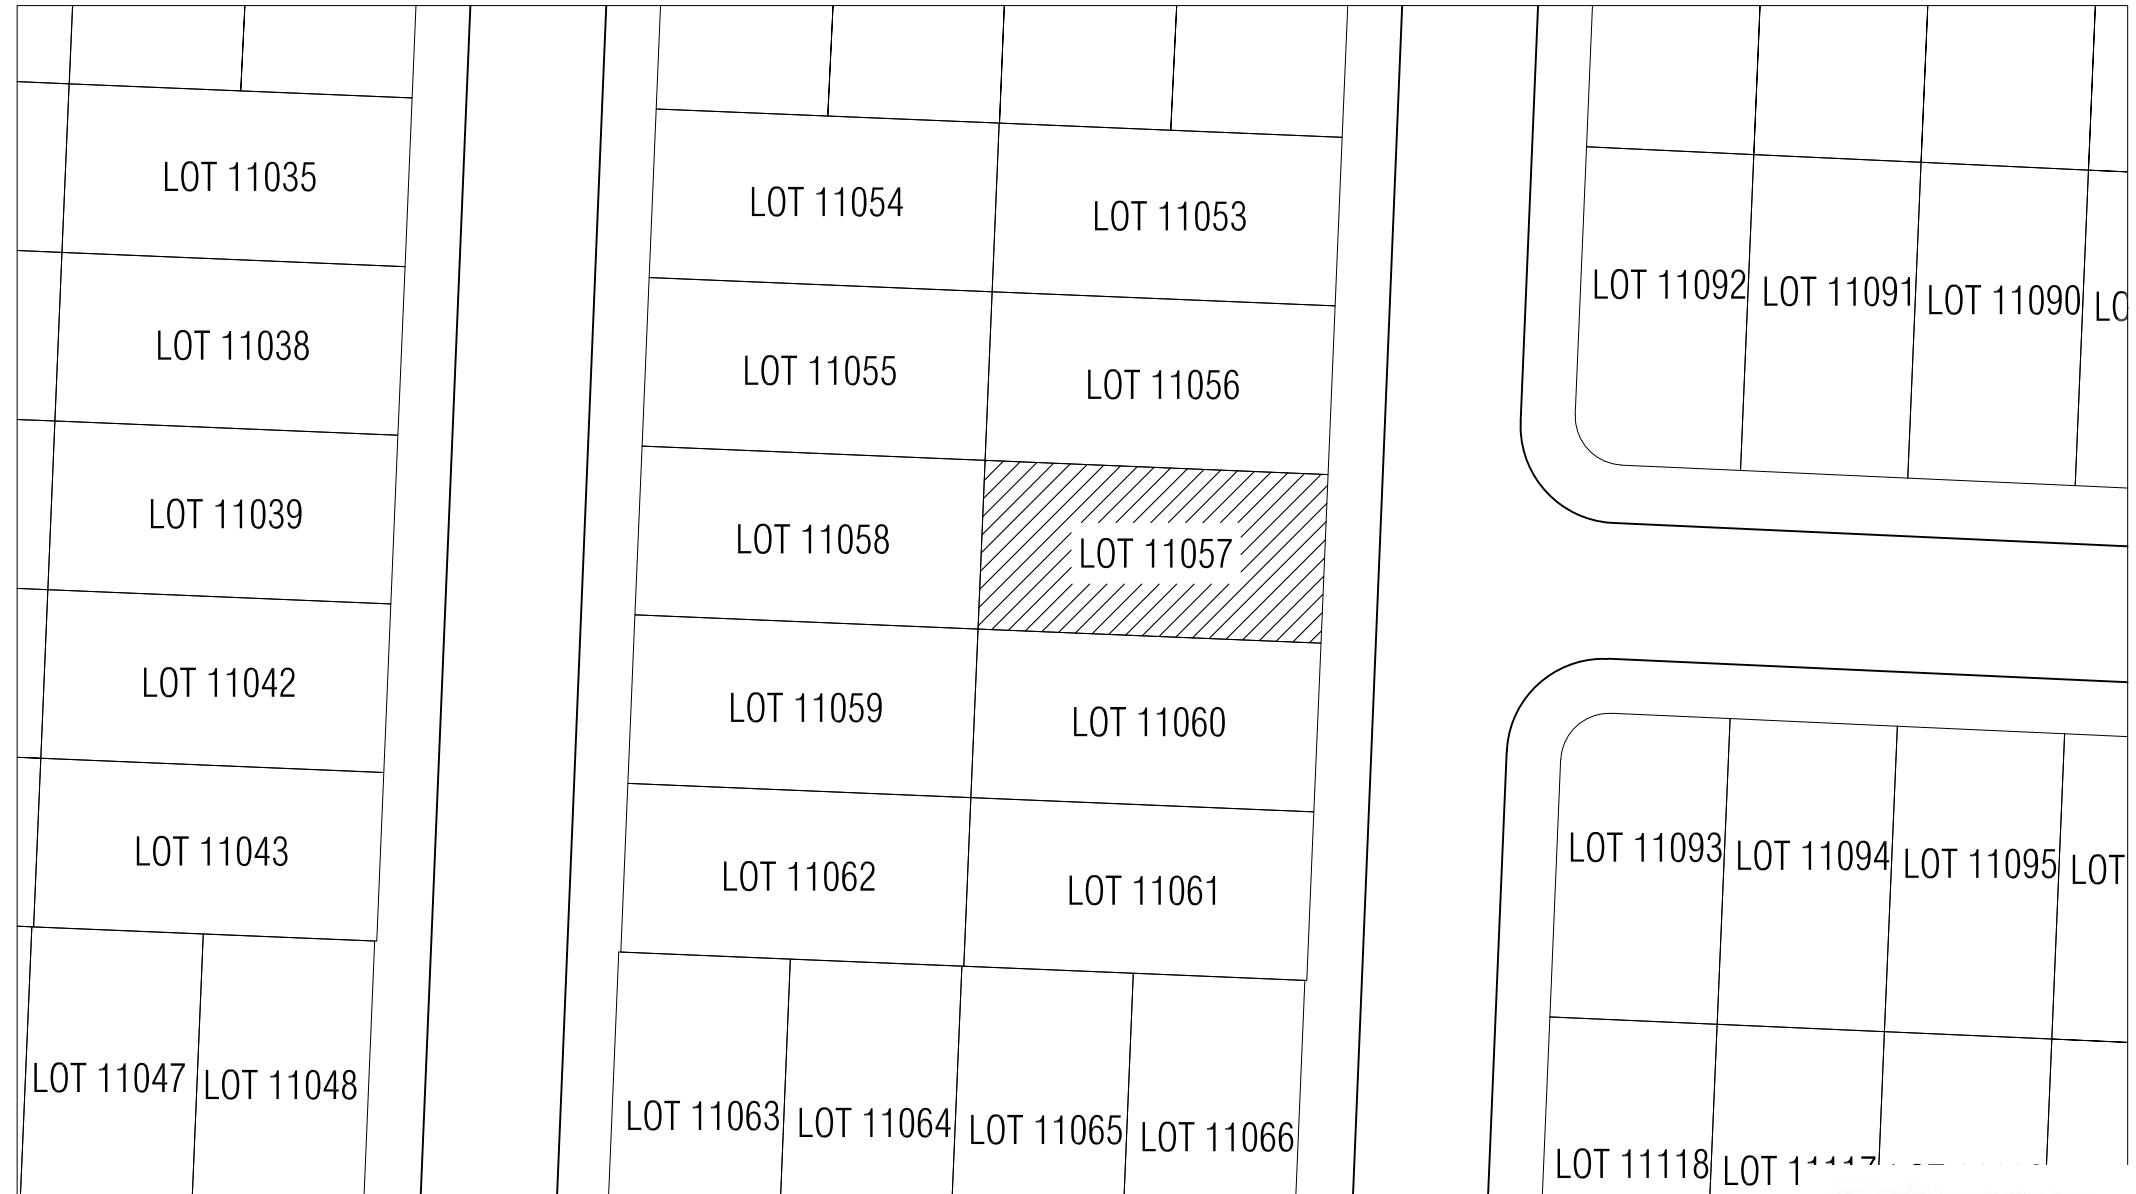

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PROJECT: LOT 11057

Scale: N.T.S


Drawn by: Mauman

Checked by:

Date: 15th March 2021

Remarks:

DRAWING: SITE CONTEXT

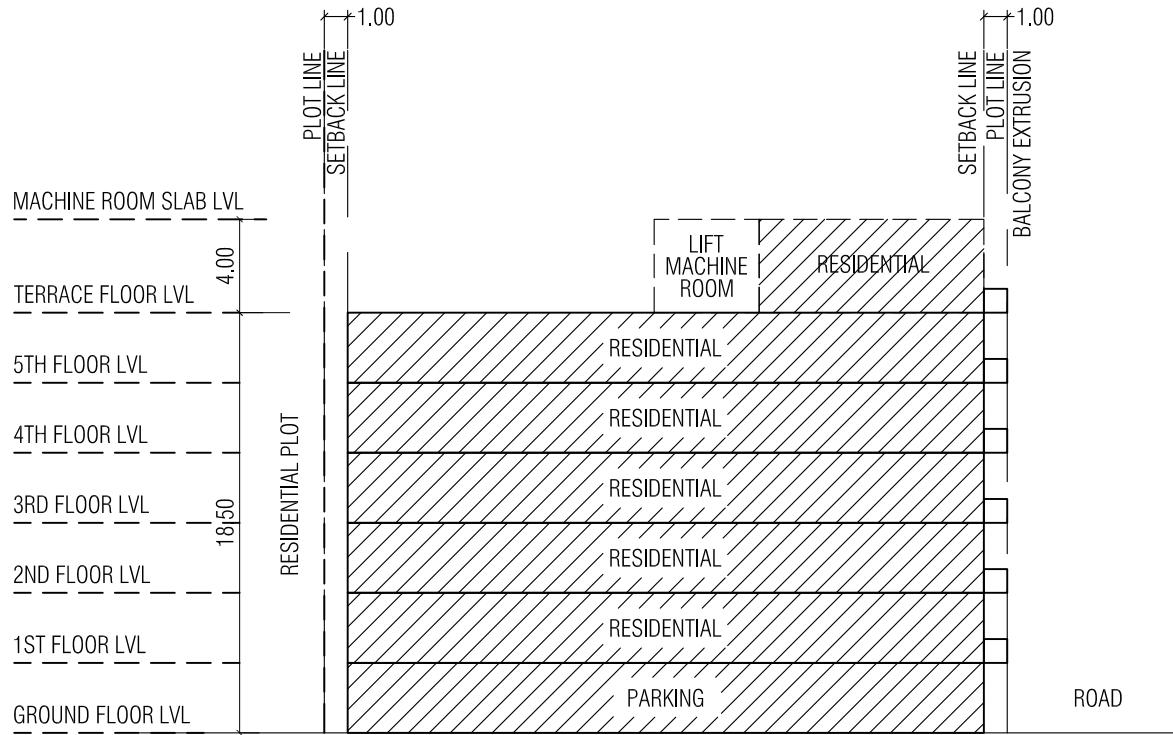

NOTE :

PLEASE NOTE THAT GROUND FLOOR FOR THIS PLOT IS TO BE
DEDICATED ONLY FOR PARKING.

PROJECT: LOT 11057

Scale: N.T.S

Drawn by: Razzan

Checked by:

Date: 7th December 2020

DRAWING: CONCEPTUAL SECTION

Remarks:



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(1) የትዕዛዣና ትርፍ ማስረጃ ነው እንደሆነ ተወስኗል፡፡ ይህንን መመሪያ በትዕዛዣና ማስረጃ ጥሩ በሆነ የተመዘገበ ነው፡፡ ይህንን ማስረጃ የሚከተሉ ሲሄድ ተወስኗል፡፡ ይህንን መመሪያ በትዕዛዣና ማስረጃ በዚህ የሆነ ትርፍ ማስረጃ ተወስኗል፡፡

(2) የትዕዛዣና ትርፍ ማስረጃ ነው እንደሆነ ተወስኗል፡፡ ይህንን ማስረጃ የሚከተሉ ሲሄድ ተወስኗል፡፡ ይህንን ማስረጃ በትዕዛዣና ማስረጃ የሚከተሉ ሲሄድ ተወስኗል፡፡ ይህንን ማስረጃ በትዕዛዣና ማስረጃ የሚከተሉ ሲሄድ ተወስኗል፡፡

(a) የትዕዛዣና ትርፍ ነው 7A እና የትዕዛዣና ማስረጃ የሚከተሉ ሲሄድ ተወስኗል፡፡ ይህንን ማስረጃ የሚከተሉ ሲሄድ ተወስኗል፡፡

(b) የትዕዛዣና ትርፍ ማስረጃ ነው እንደሆነ ተወስኗል፡፡ ይህንን ማስረጃ የሚከተሉ ሲሄድ ተወስኗል፡፡

(c) የትዕዛዣና ትርፍ ማስረጃ ነው እንደሆነ ተወስኗል፡፡ ይህንን ማስረጃ የሚከተሉ ሲሄድ ተወስኗል፡፡

(d) የትዕዛዣና ትርፍ ማስረጃ ነው እንደሆነ ተወስኗል፡፡ ይህንን ማስረጃ የሚከተሉ ሲሄድ ተወስኗል፡፡ ይህንን ማስረጃ የሚከተሉ ሲሄድ ተወስኗል፡፡ ይህንን ማስረጃ የሚከተሉ ሲሄድ ተወስኗል፡፡

(1) የሆነ ትርፍ ማስረጃ

(2)


(3) የሆነ ትርፍ ማስረጃ

-11-

(e) የትዕዛዣና ትርፍ ማስረጃ ነው 10 እና የትዕዛዣና ማስረጃ የሚከተሉ ሲሄድ ተወስኗል፡፡ ይህንን ማስረጃ የሚከተሉ ሲሄድ ተወስኗል፡፡ ይህንን ማስረጃ የሚከተሉ ሲሄድ ተወስኗል፡፡

- (ر) ملکیت نہیں ہے اور دیگر ملکیت میں نہیں بھروسہ کرنا چاہیے اسی وجہ پر حکومت کو مکالمہ کرنے کا سبقتار طور پر کیا جائے۔ ڈیکھیں کہ ملکیت میں نہیں بھروسہ کرنا چاہیے، ملکیت میں نہیں بھروسہ کرنا چاہیے اسی وجہ پر حکومت کو مکالمہ کرنے کا سبقتار طور پر کیا جائے۔
- (سر) حکومت کی نئی نیت 9 کاہر قرآنی عقیدے کے مطابق حکومت کو مکالمہ کرنے کا سبقتار طور پر ڈیکھیں کہ ملکیت میں نہیں بھروسہ کرنا چاہیے۔ ڈیکھیں کہ حکومت کو مکالمہ کرنے کا سبقتار طور پر ڈیکھیں کہ ملکیت میں نہیں بھروسہ کرنا چاہیے۔
- (مر) عیریں تریں کیوں دیکھو تو حکومت کے سبقتار ڈیکھیں کہ ملکیت میں نہیں بھروسہ کرنا چاہیے۔ ملکیت میں نہیں بھروسہ کرنا چاہیے۔ ملکیت میں نہیں بھروسہ کرنا چاہیے۔ ملکیت میں نہیں بھروسہ کرنا چاہیے۔
- (سر) حکومت کی نئی نیت 3 کاہر قرآنی عقیدے کے مطابق حکومت کو مکالمہ کرنے کا سبقتار طور پر کیا جائے اور ملکیت میں نہیں بھروسہ کرنا چاہیے۔ ملکیت میں نہیں بھروسہ کرنا چاہیے۔ ملکیت میں نہیں بھروسہ کرنا چاہیے۔
- (مر) حکومت کی نئی نیت 0.75 کاہر قرآنی عقیدے کے مطابق حکومت کو مکالمہ کرنے کا سبقتار طور پر کیا جائے اور ملکیت میں نہیں بھروسہ کرنا چاہیے۔ ملکیت میں نہیں بھروسہ کرنا چاہیے۔
- (آ) دیگر ملکیت میں نہیں بھروسہ کرنا چاہیے اور ملکیت میں نہیں بھروسہ کرنا چاہیے۔
- (ع) دیگر ملکیت میں نہیں بھروسہ کرنا چاہیے اور ملکیت میں نہیں بھروسہ کرنا چاہیے۔
- (ب) حکومت میں کام کرنے والے افراد کو حکومت کے سبقتار طور پر کیا جائے اور حکومت کے سبقتار طور پر کیا جائے اور ملکیت میں نہیں بھروسہ کرنا چاہیے۔

Annex 1(A)

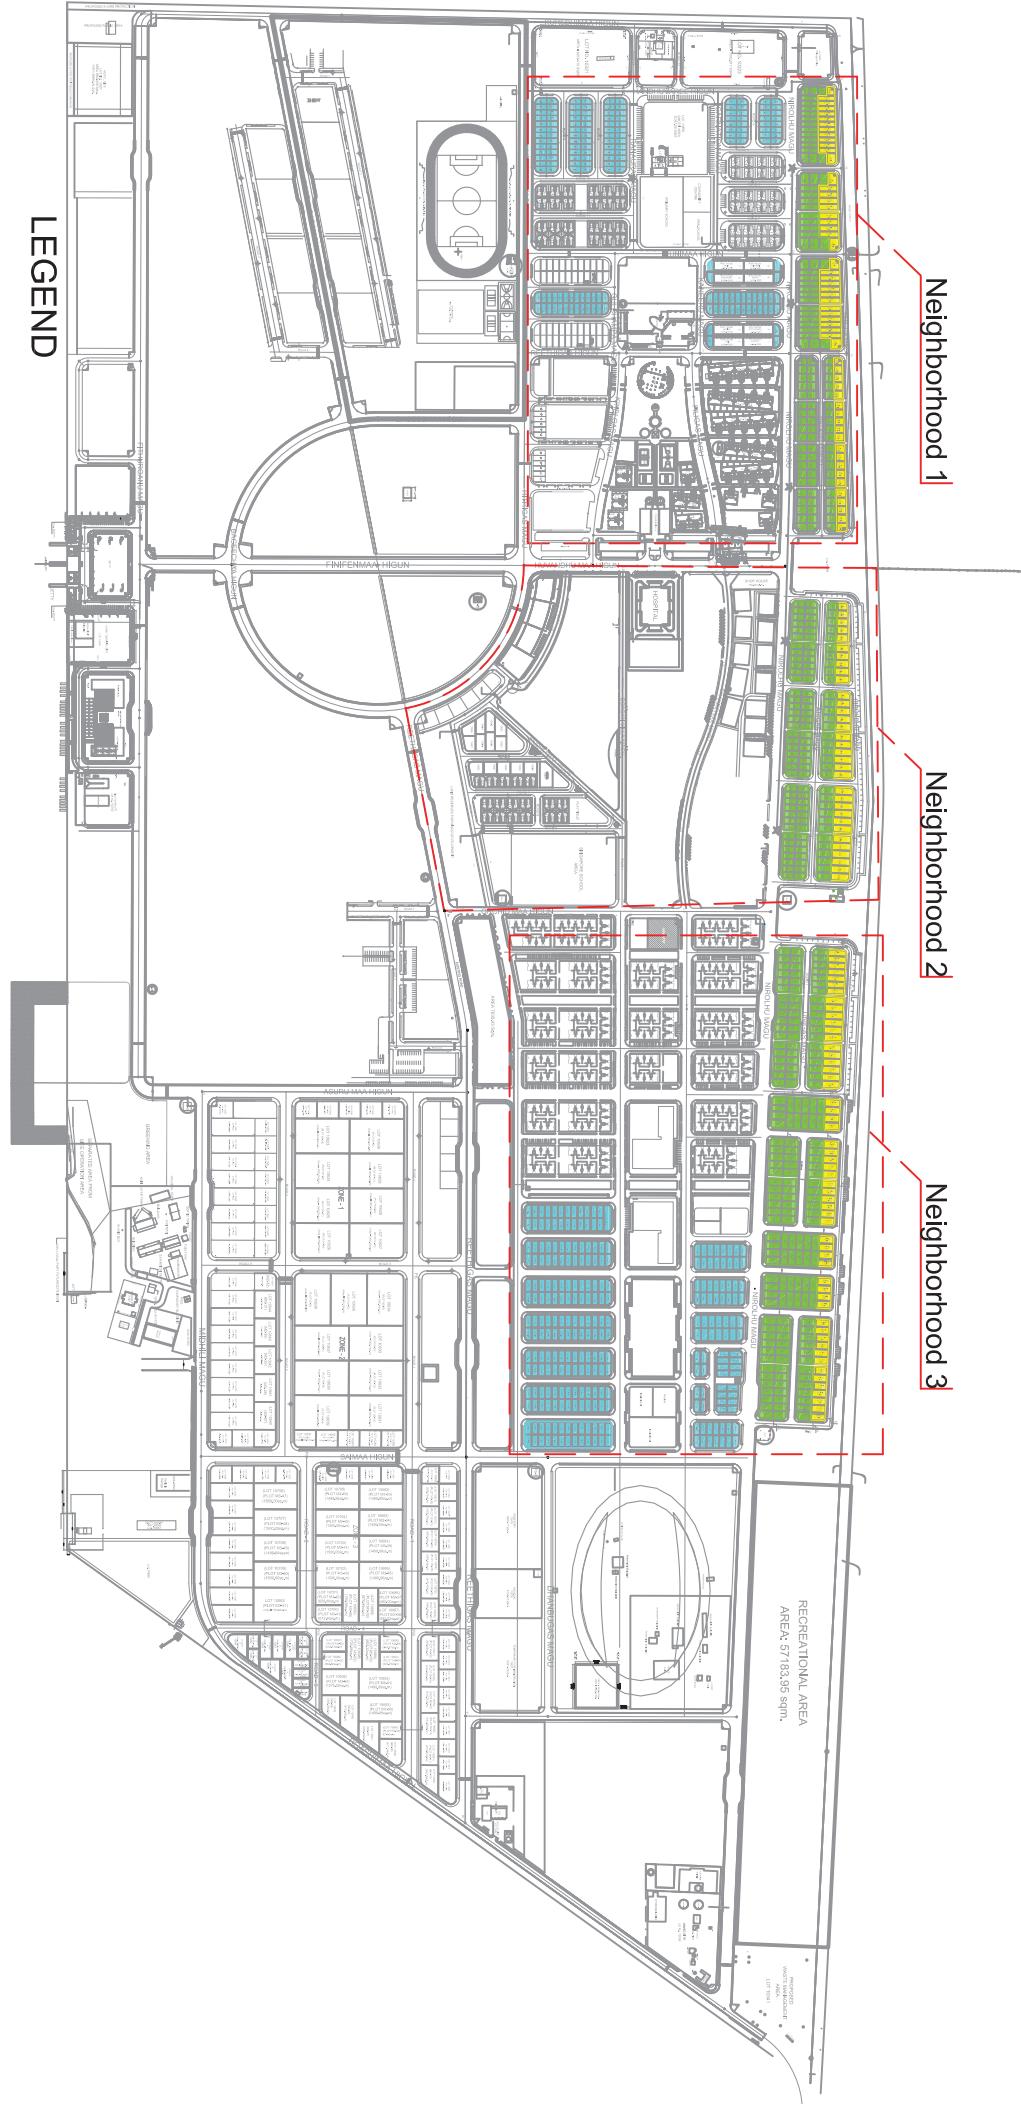

DRAWING: HULHUMALE' RESIDENTIAL AREAS

Scale: NTS
Drawn by: Kishma

Checked by: Sadiq

Date: 4th June 2015

Remarks:

Page no: 5



Annex 1(B)

Drawing: Neighborhood 1 Plots

Drawn by: Kaamil

Checked by: Saffiuwa

Date: 5th February 2012

Remarks:

LEGEND

■ Beach Front Plots ■ Beach Side Plots ■ Standard Plots



HOUSING DEVELOPMENT CORPORATION

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EMAIL : planning@hdc.com.mv



Annex 1(C)

Drawing: Neighborhood 2 Plots

Drawn by: Kaamil

Checked by: Saffiuwa

Date: 5th February 2012


Remarks:

LEGEND

■ Beach Front Plots ■ Beach Side Plots ■ Standard Plots



Annex 1(D)

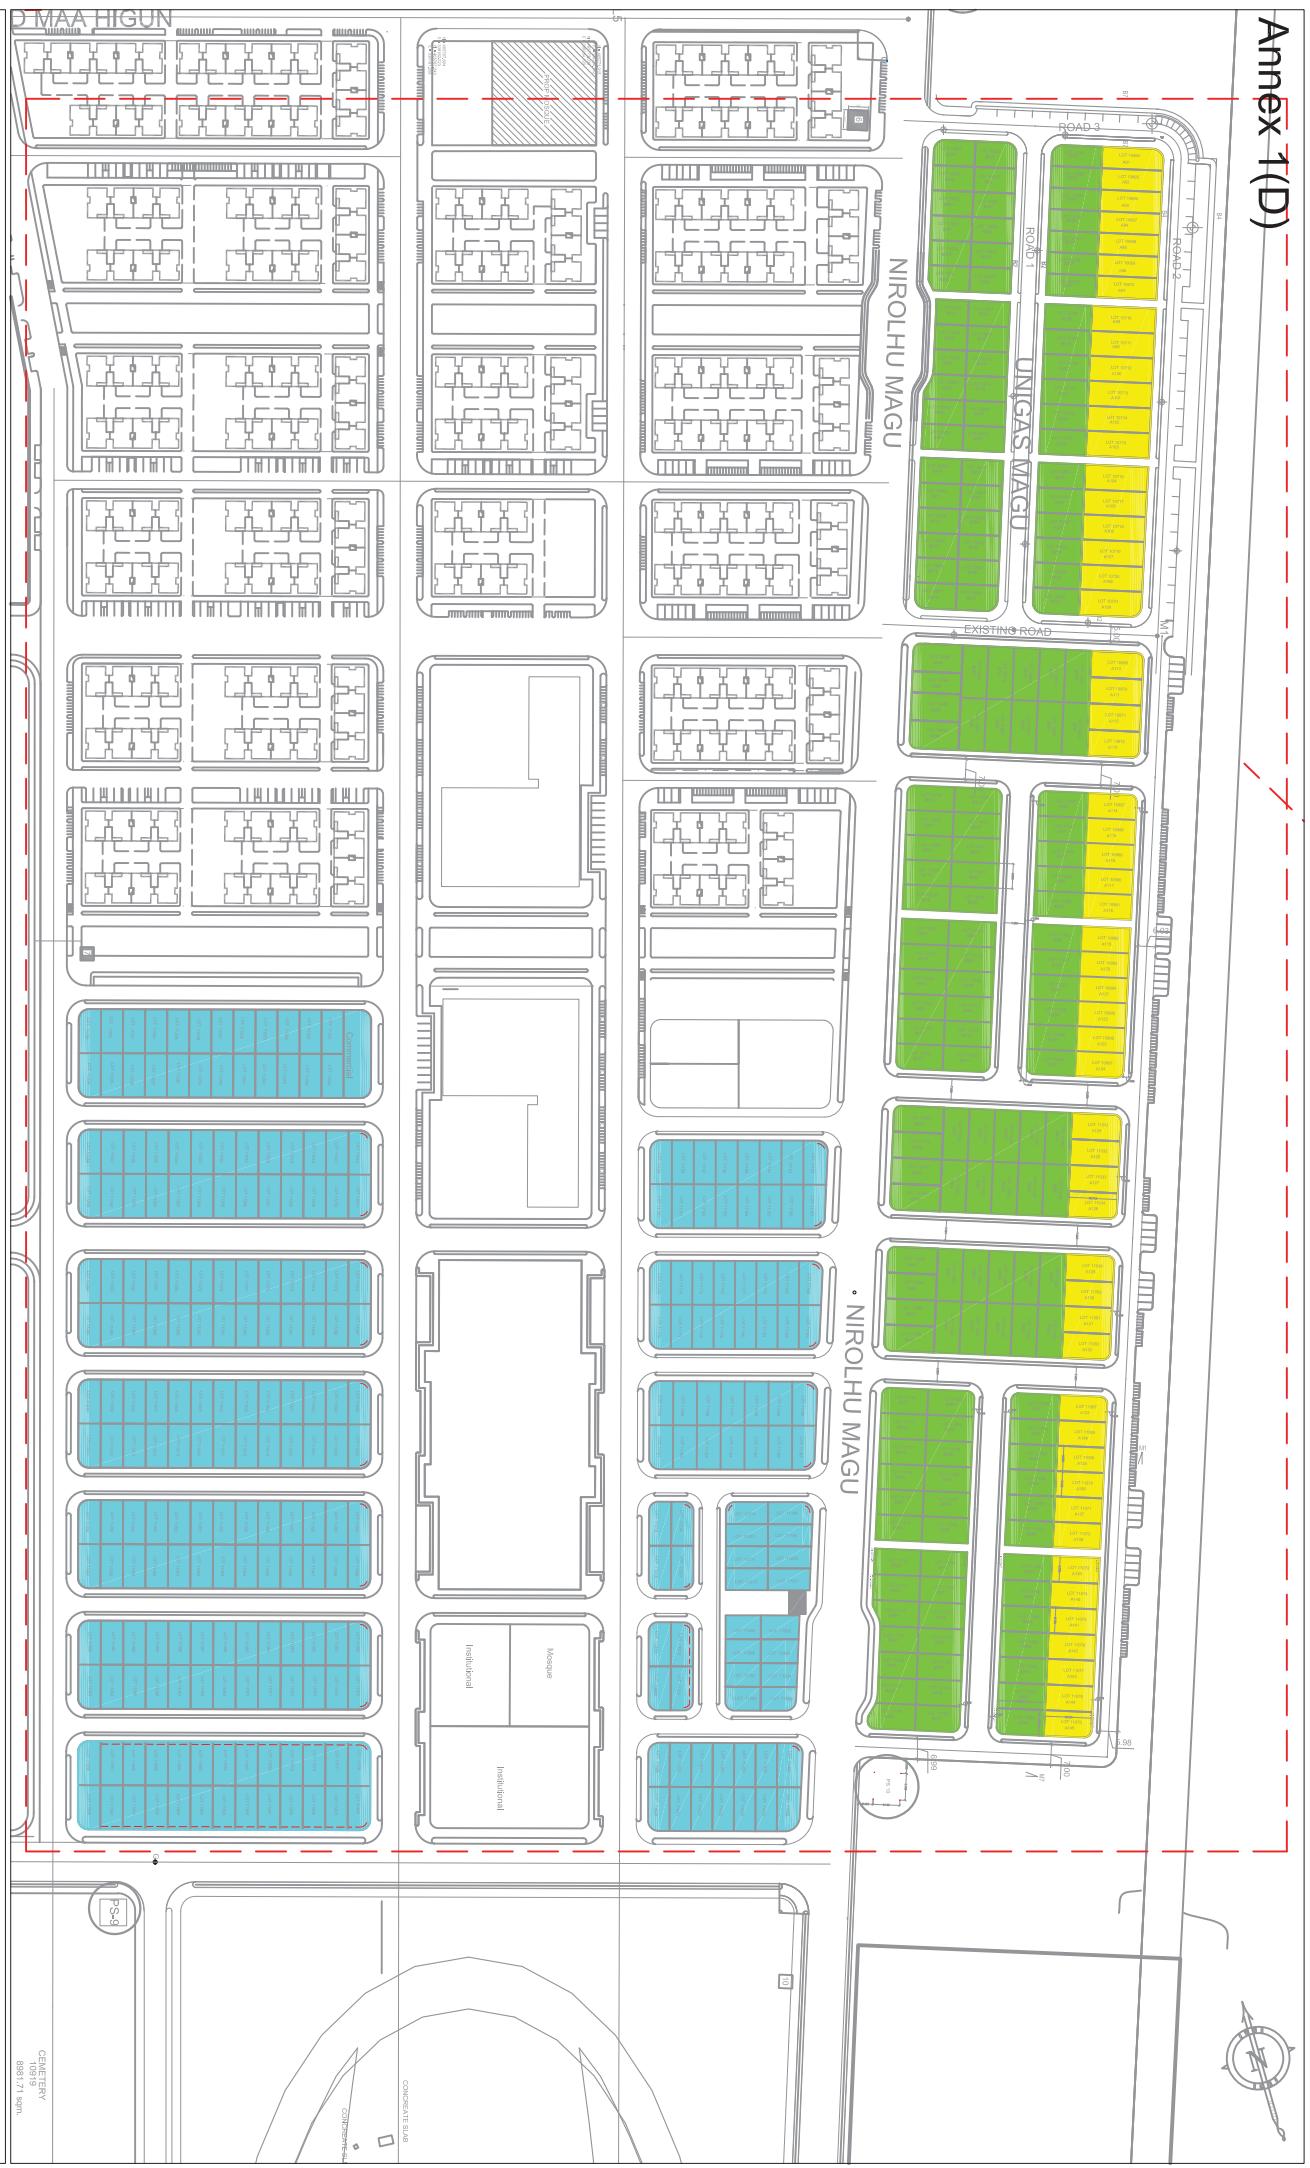

LEGEND

■ Beach Front Plots ■ Beach Side Plots ■ Standard Plots

Drawing: Neighborhood 3 Plots
Checked by: Saffiuwa
Date: 5th February 2012

Remarks:

Drawn by: Kaamil

Drawing: Neighborhood 1 Set back Plan and Garage Location

Drawn by: I. Saeed


Checked by: Safiy

Date: 4th June 2015

Remarks:

LEGEND

- Set back line
- Garage location
- Optional garage location for corner plots

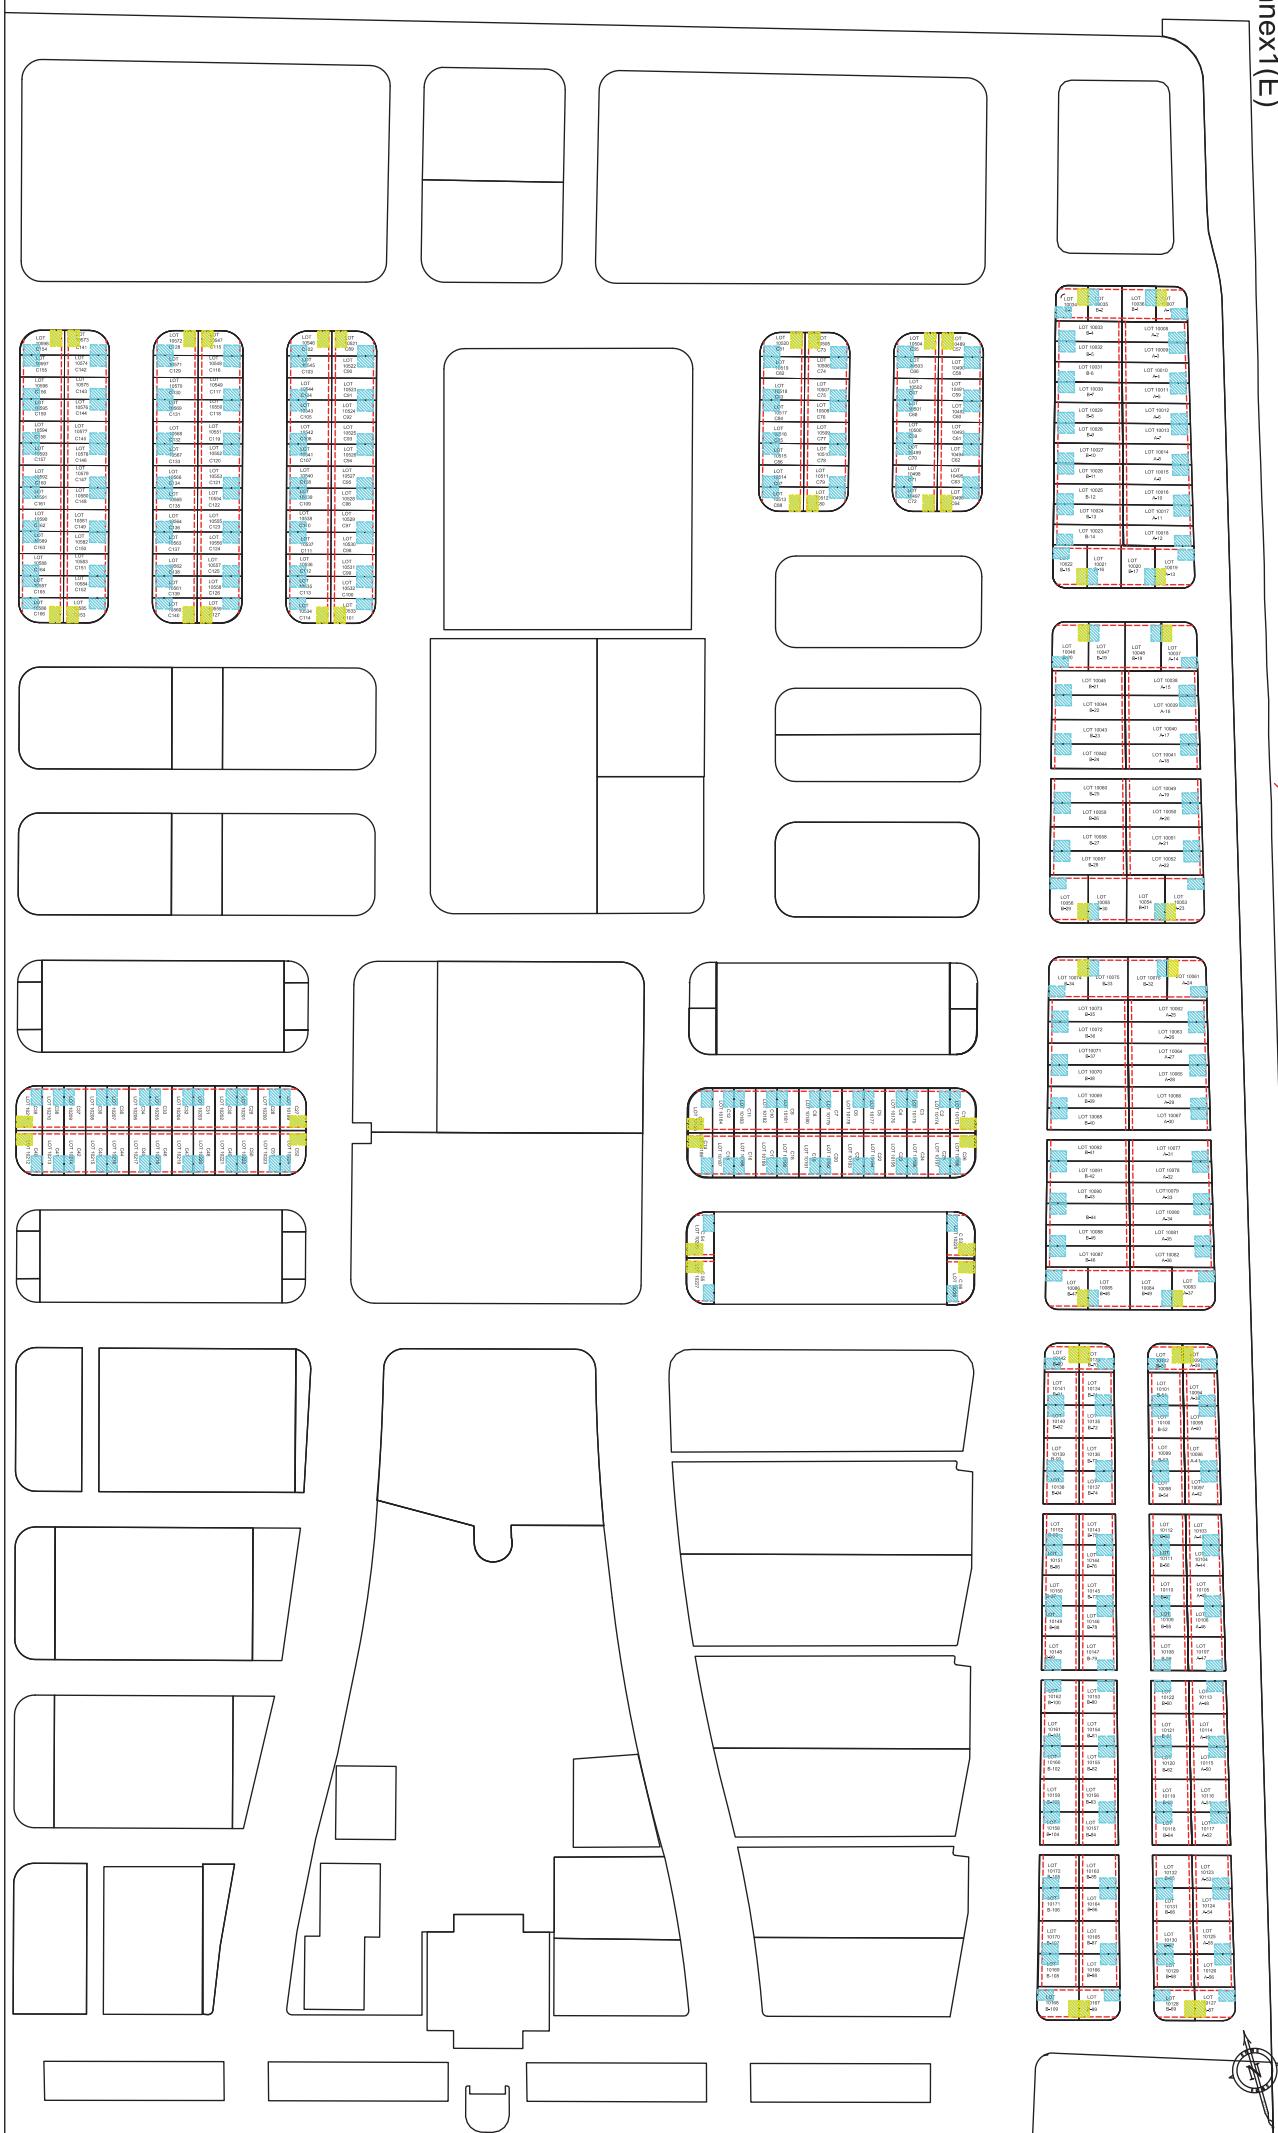

Drawing: Neighborhood 2 Set back Plan and Garage Location

Drawn by: I. Senevi

Checked by: Saffura

Date: 4th June 2015

Remarks:

LEGEND

- Set back line
- Garage location
- Optional garage location for corner plots



Drawing: Neighborhood 3 Set back Plan and Garage Location

Drawn by: I. Saeed


Checked by: Saffiya

Date: 4th June 2015

Remarks:

LEGEND

- Set back line
- Garage location
- Optional garage location for corner plots

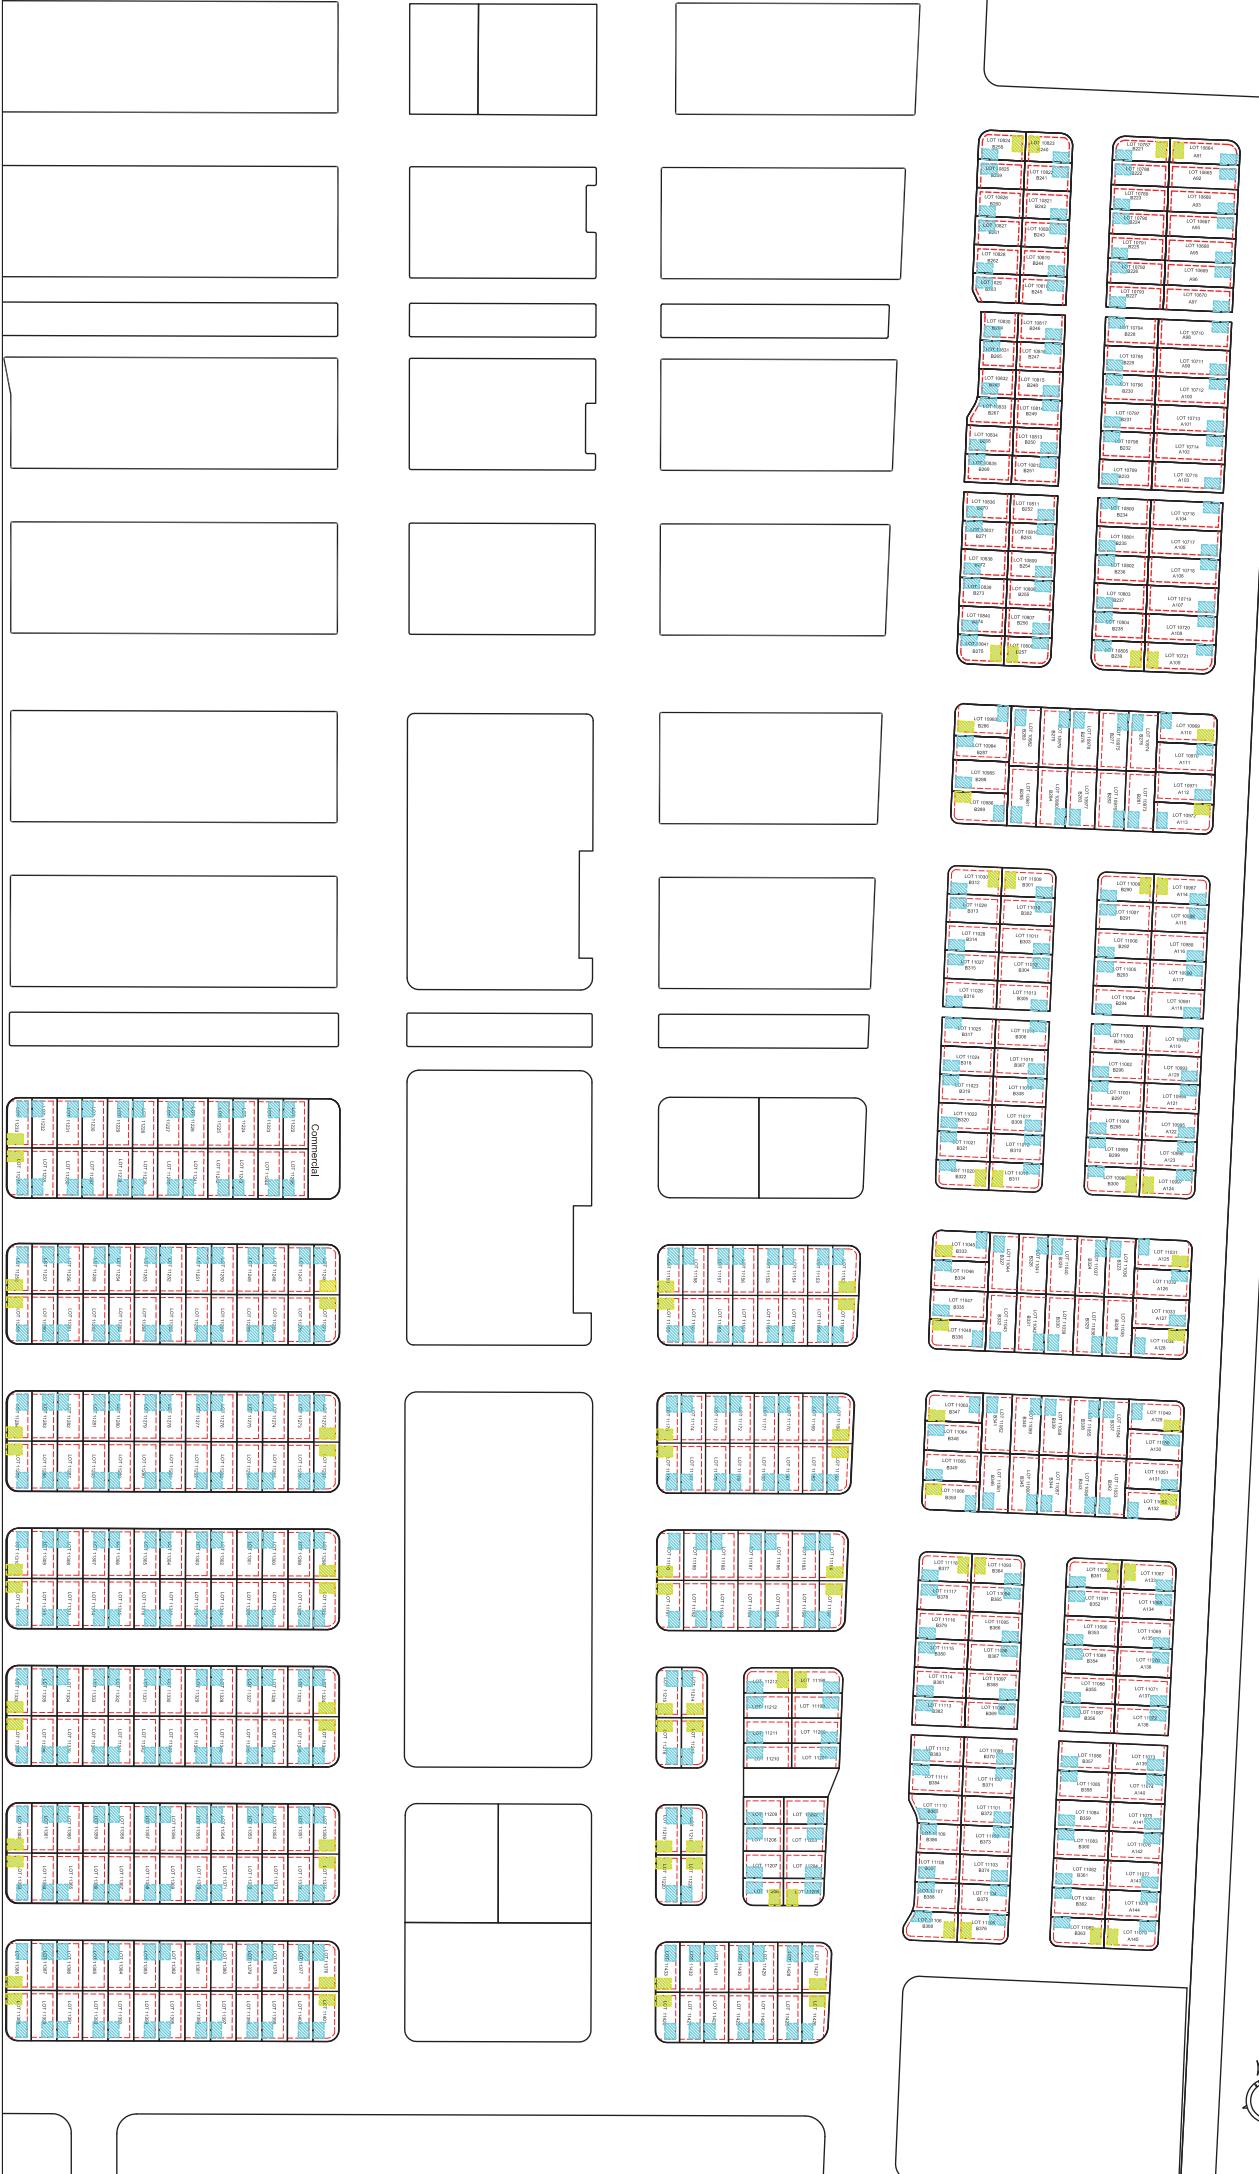

ANNEX 1 (H)

CORNER PLOTS WITH SIDE SETBACK TO ROAD

N2	N3	Veshifahi
PLOT NUMBER		
10345	10664	11152
10354	10787	11167
10411	10823	11168
10422	10824	11183
10359	10721	11184
10360	10805	11197
10428	10806	11198
10429	10841	11213
10365	10972	11214
10374	10986	11217
10435	10987	11218
10446	11008	11221
10380	11009	11427
10381	11030	11426
10453	10997	11246
10454	10998	11271
10387	11019	11272
10398	11020	11297
10461	11034	11298
10474	11048	11323
10404	11049	11324
10405	11063	11349
10481	11067	11350
10482	11092	11375
	11093	11376
	11118	11401
	11079	
	11080	
	11105	
	11106	

DRAWING : Corner plots with side setback to road

Scale : NTS


Drawn by: Samih

Checked by:


Date: 13-May-15

Remarks:

Annex 2

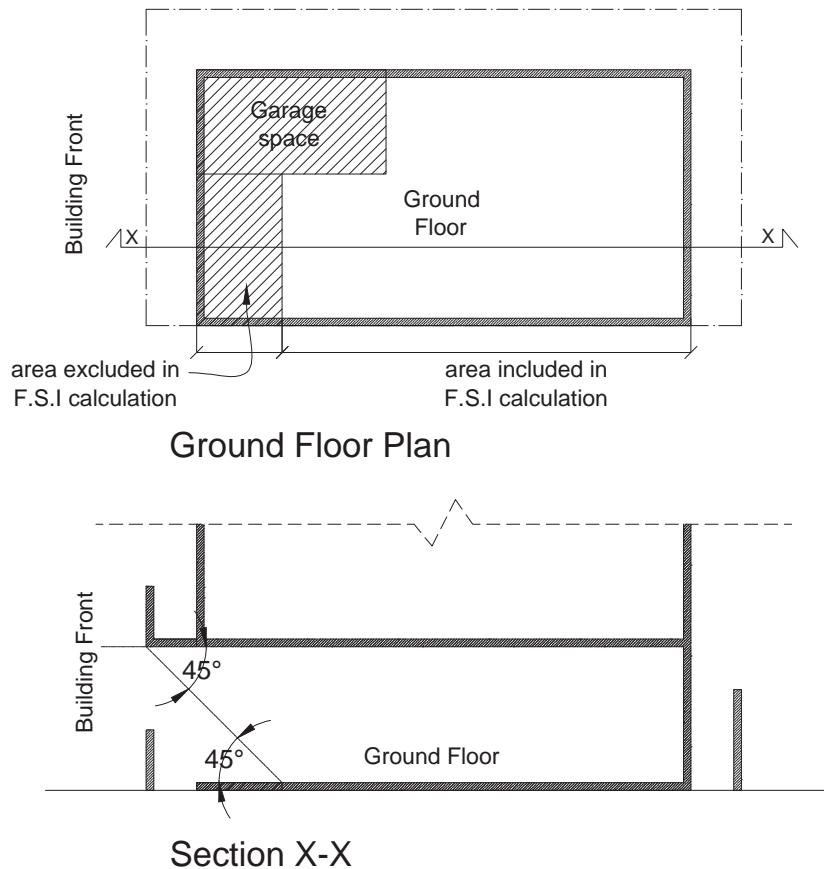

Annex 3

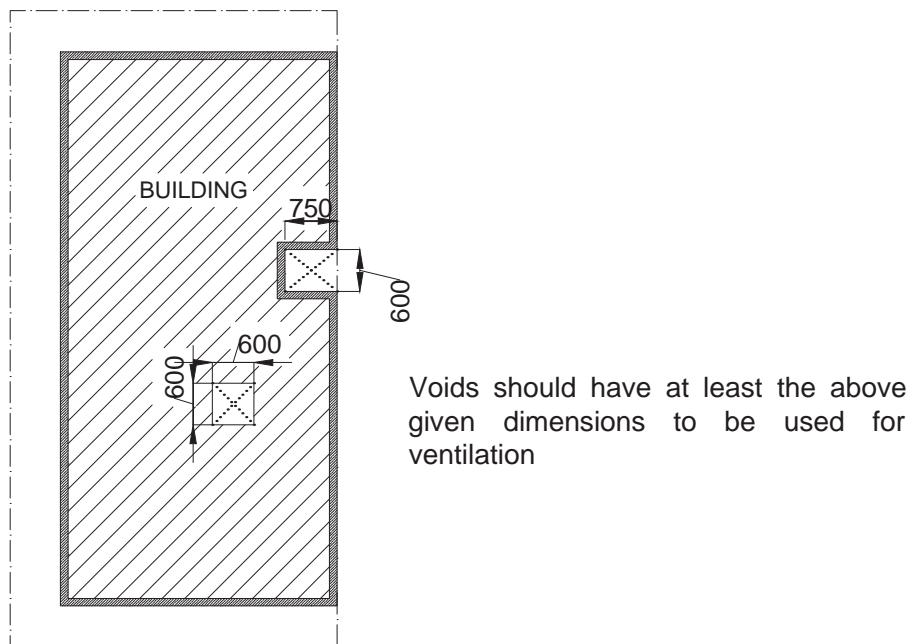

DRAWING : F.S.I calculation and void space

Scale : NTS

Drawn by: Samih


Checked by:

Date: 13-May-15

Remarks:

Annex 4

Balconies excluded from the F.S.I

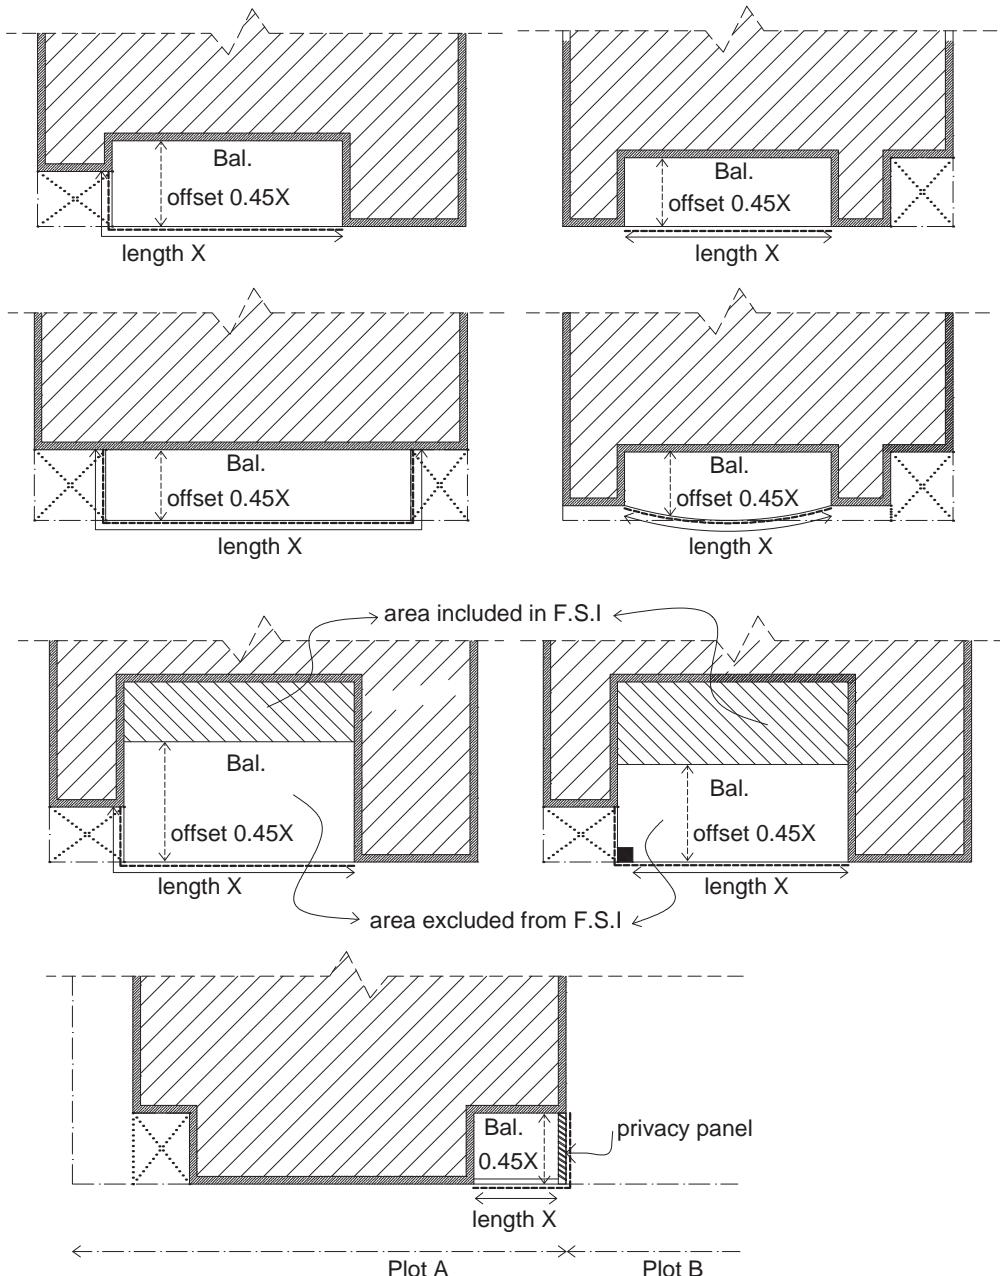

----- indicates line to be offset

←→ indicates uninterrupted length

If the whole balcony area is within the offset line and peripheral line, balcony is free of FSI. However, if an area of the balcony exceeds beyond the offset line that area will be included in F.S.I calculation

DRAWING : Balconies included and excluded in F.S.I calculation

Scale : NTS


Drawn by: Samih

Checked by:

Date: 13-May-15

Remarks:

Annex 5

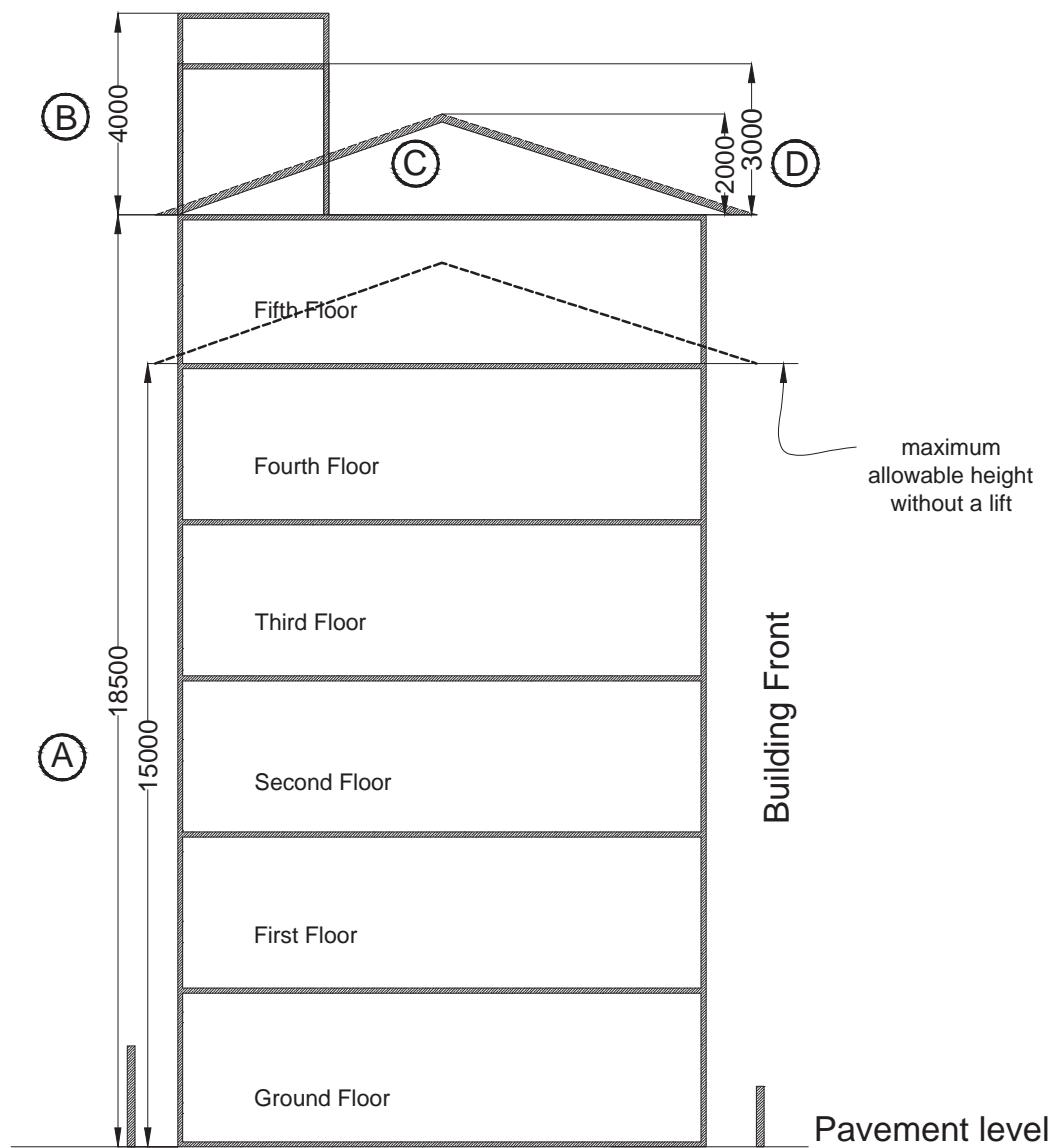

A - Building should have a maximum height of 18.5m

B - Lift machine room and staircase enclosed area should have a maximum of 4m from terrace slab level


C - If the building contains only a staircase without a lift, staircase area should have a maximum of 3m in height from terrace floor slab level

D - If a pitch roof is provided, it should have a maximum height of 2m from the terrace floor level (roof beam spring line level)

Annex 6



Annex 6(A)

Neighbourhood 1

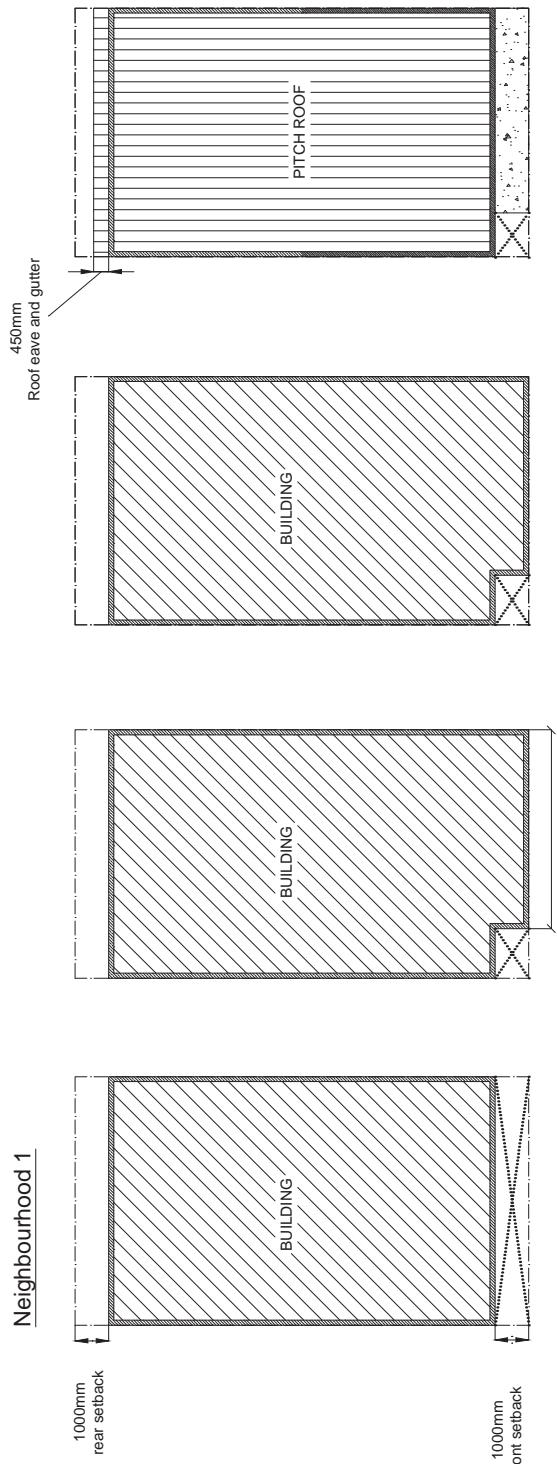

Annex 6(B)

Neighbourhood 2 & 3

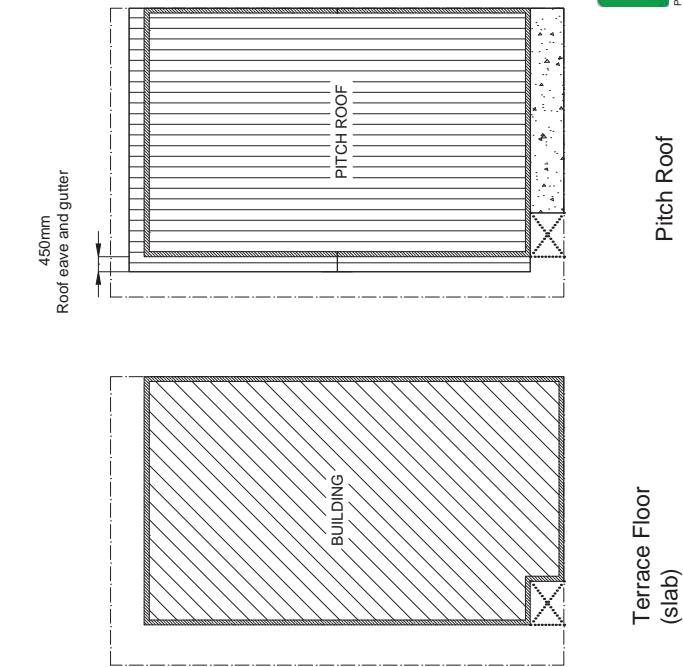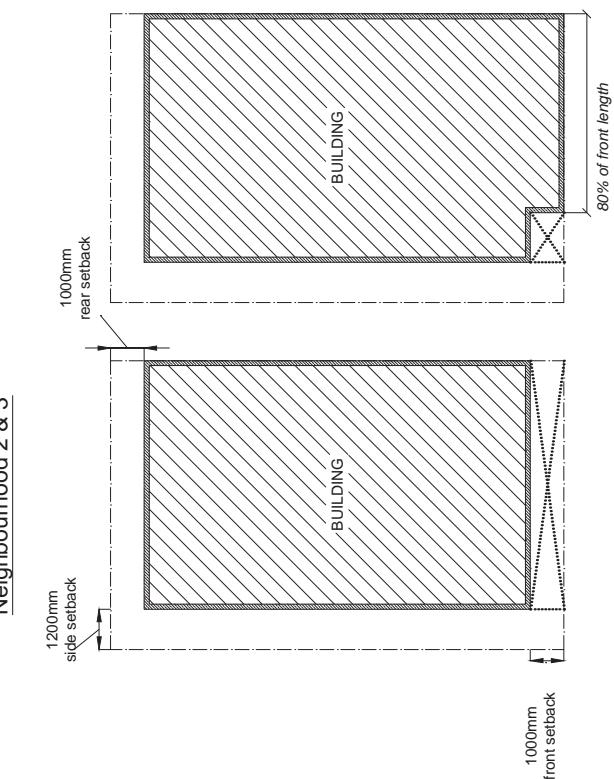


DRAWING : Built up area
Scale: 1:15
Drawn by: Samith
Checked by:

Date: 15-May-15
Planned by:


Annex 7

Annex 7(A)

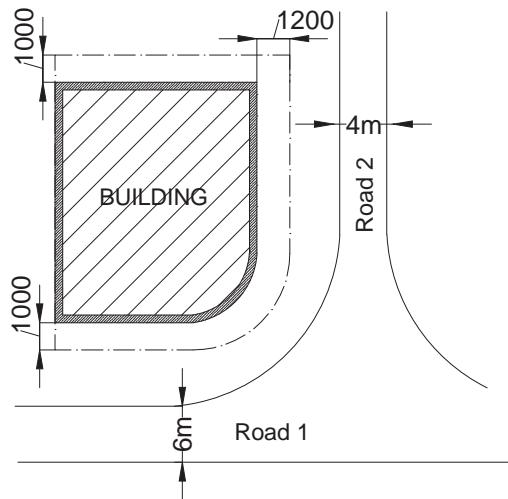

- The side with 1m setback facing the road will be considered as the front of the building

Annex 7(B)

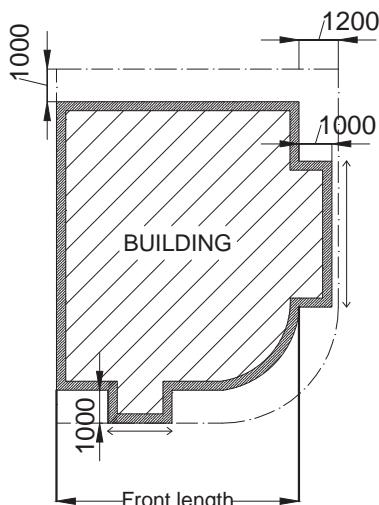

←→ length of the projection onto the setback

The length of the projection onto the side and front setback should be less than or equal to the 80% of the length of the building on the respective side

When projecting the building structure onto the side setback it should be within a width of 1m from the setback line

DRAWING : Building front of corner plots and structure projection onto setback

Scale : NTS


Drawn by: Samih

Checked by:

Date: 13-May-15

Remarks:


Annex 8

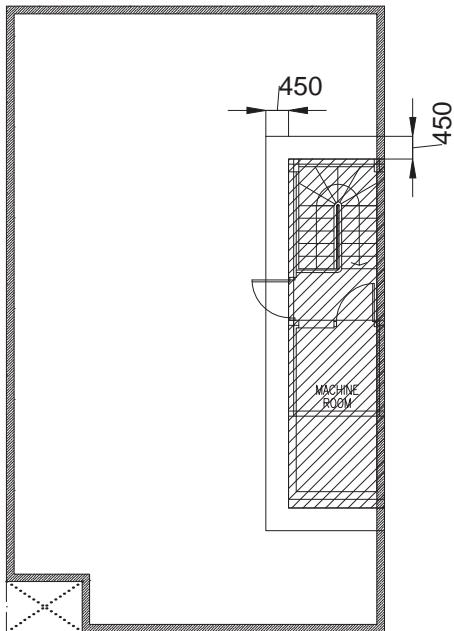

Covered area should not be more than 15sqm.


— 0.45m overhang from the wall can be allowed as shown in the diagram

Annex 9

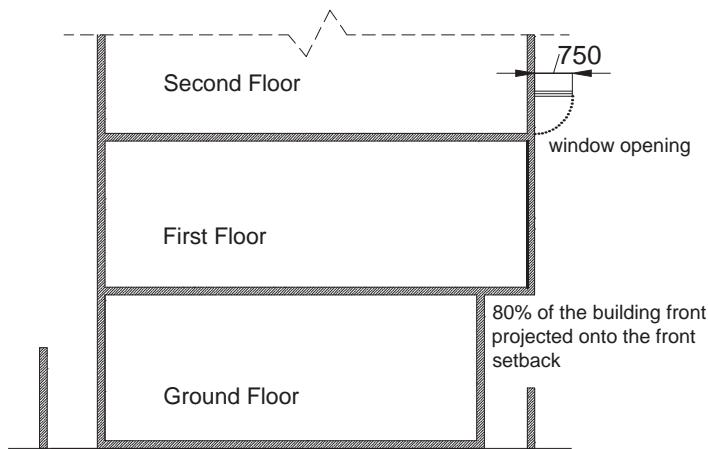

The maximum length of window panel projected from the periphery of the building structure should not be more than 0.75m

Annex 10

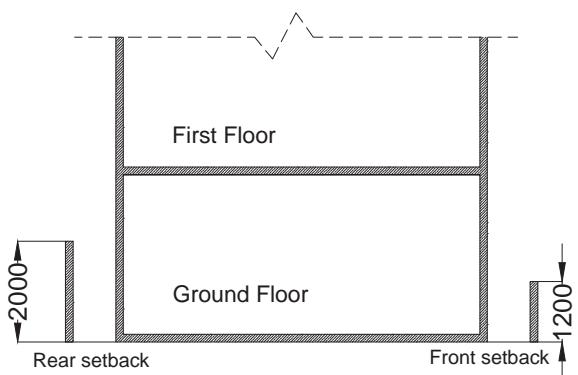

- Boundary wall on the front setback should be of maximum 1.2m from pavement level

- Boundary wall on side and rear setback should be of maximum 2m from pavement level

DRAWING : Terrace covered area, window opening and boundary wall

Scale : NTS


Drawn by: Samih

Checked by:

Date: 13-May-15

Remarks:

Annex 11

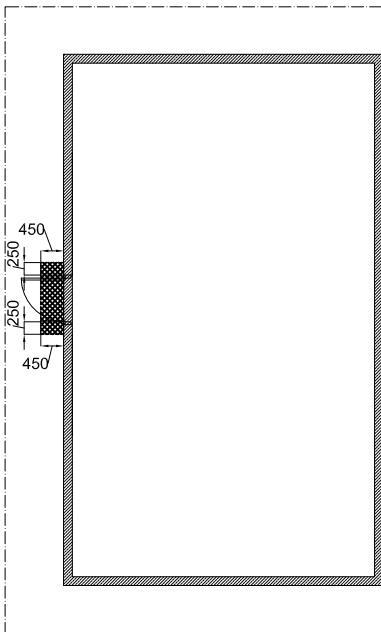


Ground Floor Plan



Covered area should not exceed 0.25m from either side of the entrance door. Maximum allowable extrusion from the building for the shade is 0.45m.

Annex 12

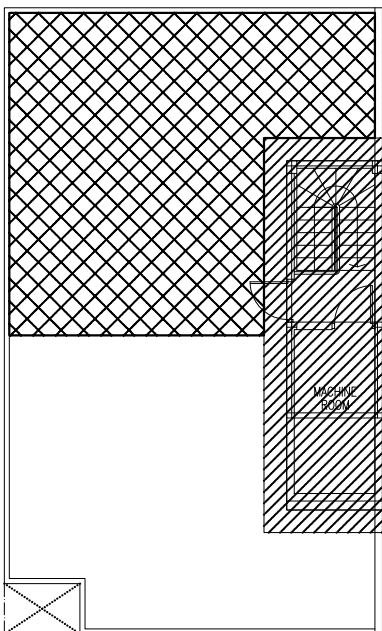

Terrace Floor Plan



Covered area for stairwell and lift machine room should not be more than 15sqm.



Allowable 50% of remaining terrace area.

1.8	18 ઘણું સ્રોમ 5 ગુર્જાત કાન્પ એન્ટ્રી ફોર્મ વિસ્તૃત કેવી સ્વરૂપ હૈ : જે કાન્પ કાર્ડ એન્ટ્રી ફોર્મ માટે મુશ્કેલી અને બધા કાન્પ એન્ટ્રી ફોર્મ્સ ની જાહેર રીતે કાન્પ એન્ટ્રી ફોર્મ કરી શકી નથી. જે કાન્પ એન્ટ્રી ફોર્મ કરી શકી નથી, તેની માટે કોઈ ઉપયોગ નથી, કાન્પ એન્ટ્રી ફોર્મ કરી શકી નથી તો કાન્પ એન્ટ્રી ફોર્મ કરી શકી નથી.
30	30 ઘણું સ્રોમ ગુર્જાત કાન્પ એન્ટ્રી ફોર્મ વિસ્તૃત કેવી સ્વરૂપ હૈ : જે કાન્પ એન્ટ્રી ફોર્મ કરી શકી નથી, તેની માટે કાન્પ એન્ટ્રી ફોર્મ કરી શકી નથી તો કાન્પ એન્ટ્રી ફોર્મ કરી શકી નથી.
	ગુર્જાત સર્વોચ્ચ કાન્પ એન્ટ્રી ફોર્મ

સ્રોમ : કાન્પ એન્ટ્રી ફોર્મ કરી શકી નથી તો એન્ટ્રી ફોર્મ કરી શકી નથી તો એન્ટ્રી ફોર્મ કરી શકી નથી.

ગુર્જાત સર્વોચ્ચ કાન્પ એન્ટ્રી ફોર્મ વિસ્તૃત કેવી સ્વરૂપ

દ્વારાનાં પ્રાપ્ત સ્વરૂપ

1 - કાન્પ એન્ટ્રી ફોર્મ વિસ્તૃત કેવી સ્વરૂપ હૈ (કાન્પ એન્ટ્રી ફોર્મ કરી શકી નથી, જે કાન્પ એન્ટ્રી ફોર્મ કરી શકી નથી) સર્વોચ્ચ.

2 - આ ગુર્જાત કાન્પ એન્ટ્રી ફોર્મ વિસ્તૃત કેવી સ્વરૂપ હૈ કાન્પ એન્ટ્રી ફોર્મ કરી શકી નથી.

3 - કાન્પ એન્ટ્રી ફોર્મ વિસ્તૃત કેવી સ્વરૂપ હૈ (S.I (સેંક્રિટિક્યુલર એન્ટ્રી ફોર્મ) કરી શકી નથી).

4 - કાન્પ એન્ટ્રી ફોર્મ વિસ્તૃત કેવી સ્વરૂપ હૈ :-

કાન્પ એન્ટ્રી ફોર્મ : - 1:100, 1:200, 1:500, 10000, 1:5000, 1:2000, 1:1000 •

કાન્પ એન્ટ્રી ફોર્મ : - 1:100, 1:200 •

કાન્પ એન્ટ્રી ફોર્મ : - 1:500, 1:200, 1:100 •

કાન્પ એન્ટ્રી ફોર્મ : - 1:100, 1:20, 1:50, 1:100, 1:10, 1:5, 1:2, 1:1 •

"કાન્પ એન્ટ્રી ફોર્મ વિસ્તૃત કેવી સ્વરૂપ"


દ્વારાનાં પ્રાપ્ત સ્વરૂપ

1 - ગુર્જાત સર્વોચ્ચ કાન્પ એન્ટ્રી ફોર્મ (કાન્પ એન્ટ્રી ફોર્મ વિસ્તૃત કેવી સ્વરૂપ હૈ)

કાન્પ એન્ટ્રી ફોર્મ કરી શકી નથી, કાન્પ એન્ટ્રી ફોર્મ કરી શકી નથી, કાન્પ એન્ટ્રી ફોર્મ કરી શકી નથી.

કાન્પ એન્ટ્રી ફોર્મ કરી શકી નથી, કાન્પ એન્ટ્રી ફોર્મ કરી શકી નથી, કાન્પ એન્ટ્રી ફોર્મ કરી શકી નથી (કાન્પ એન્ટ્રી ફોર્મ કરી શકી નથી).

સર્વોચ્ચ 3.2 કાન્પ એન્ટ્રી ફોર્મ કરી શકી નથી.

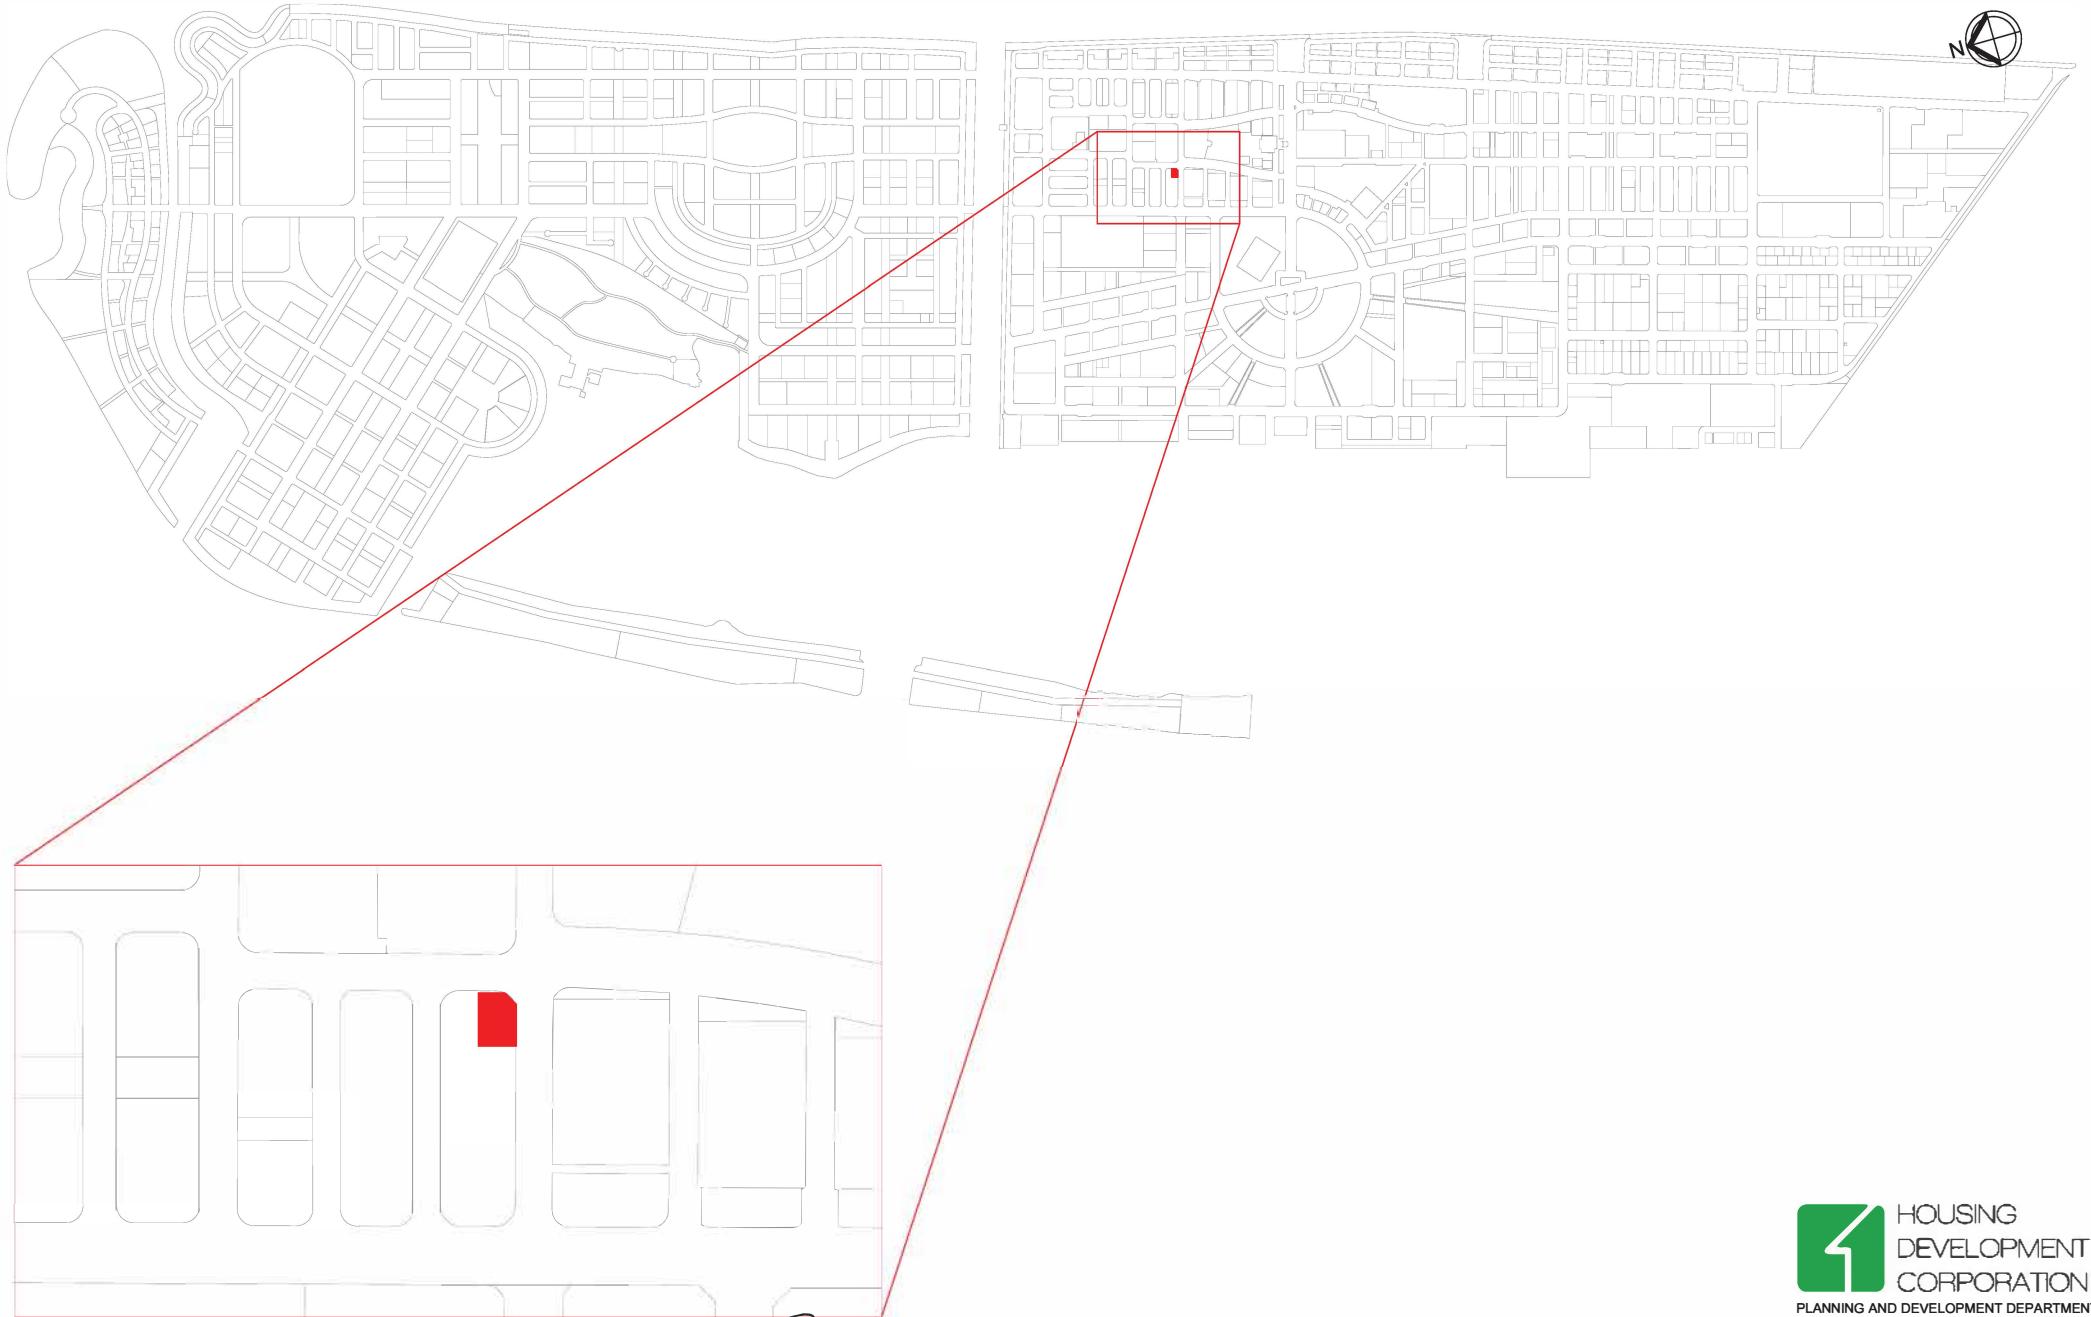

PROJECT: LOT 10901

Scale: N.T.S

Drawn by: Jilan

Checked by:

Date: 4th December 2019


Remarks:

DRAWING: LOCATION MAP



E 338339.8455
N 466439.3638

E 338337.2259
N 466430.1610

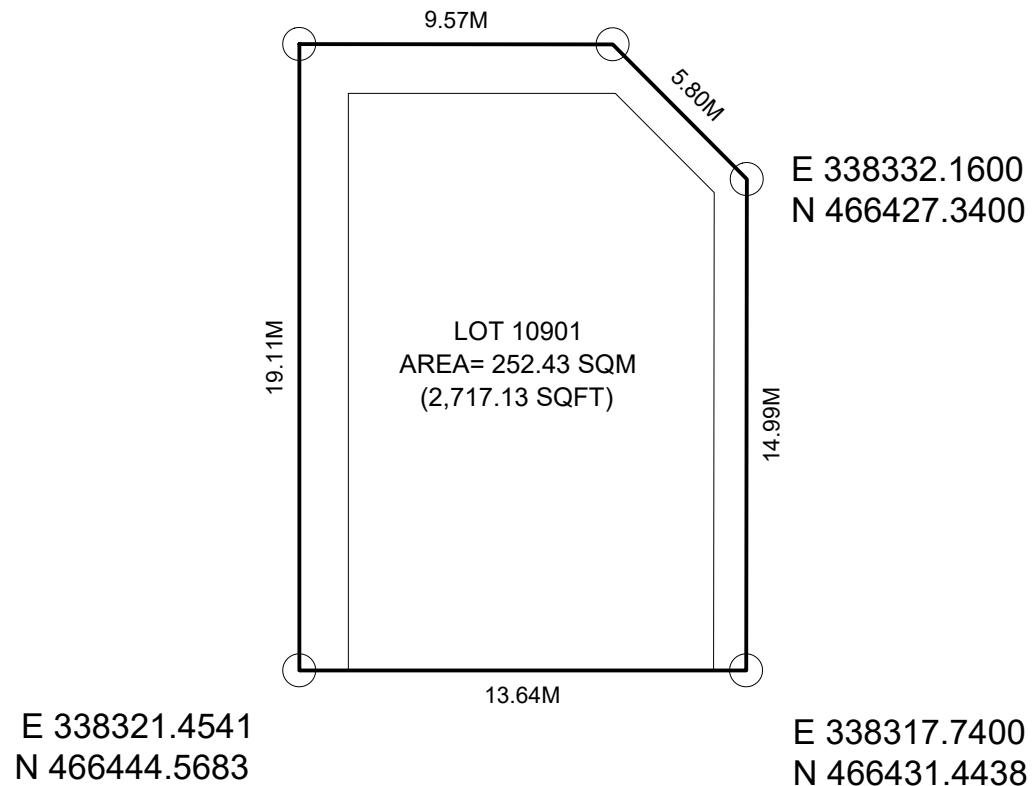

PROJECT: LOT 10901 MREIC

Scale: N.T.S

Drawn by: Jilan

Checked by: Zinaf


Date: 4th December 2019

Remarks:

DRAWING: PLOT MAP



PLANNING AND DEVELOPMENT DEPARTMENT
3RD FLOOR, HDC BUILDING HULHUMALE'
REPUBLIC OF MALDIVES
TEL. +(960)3353535, FAX +(960)3358892
EMAIL : planning@hdc.com.mv

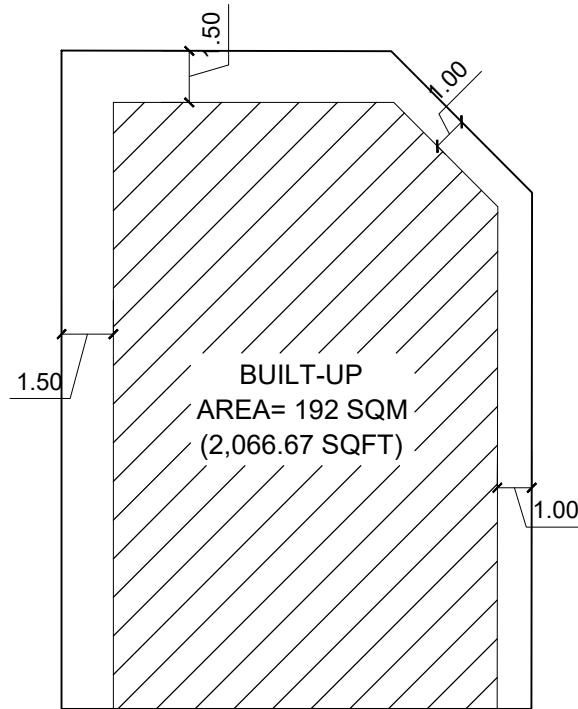

Lot Number	Parcel Number	Description	Land Use	Plot Area	Foot Print	Gross Floor Area (G.F.A)	Plot Ratio (F.S.R)	Site Coverage	Max Height / Floors	Number of units
10901	N1-56b	MREIC	Pure Residential	252.43 SQM	192.00 SQM	1,135.94 SQM	4.50	76%	8 Floors / 30.1m	16 units
				2,717 SQFT	2,066.70 SQFT	12,227.09 SQFT			26.1m bldg + 4m Lift Machine Room	

PROJECT: LOT 10901 MREIC

DRAWING: SETBACK PLAN

Scale: N.T.S

Drawn by: Jilan

Checked by:

Date: 4th December 2019

Remarks:



HULHUMALE PLANNING & DEVELOPMENT GUIDELINE:

APARTMENT COMPLEX DEVELOPMENT

1. INTRODUCTION

- 1.1 This guideline will be applicable to pure residential plots N1-56 and N1-60 of Hulhumale' phase 1 (please refer to the development drawings).
- 1.2 Concept drawings (site plan showing surrounding context, all floor plans, human and vehicle circulation, conceptual sections and elevations, parking allocations as per HDC guideline (please note that the structural design should accommodate required number of parking's), and spatial layout, showing the overall classifications and requirements of the development must be submitted to HDC for comments before proceeding to final architectural and structural drawings.
- 1.3 Final detail drawing set approval and related construction approvals need to be obtained from HDC, before the construction of any building in Hulhumale'.
- 1.4 Under these guidelines, a building is defined to be a constructed dwelling that is not movable/portable within a given plot and one that is finished using different materials and is constructed to a certain standard that is acceptable to HDC.

2. LAND USAGE

- 2.1 These allocated land plots are for the construction of pure residential complexes whereby its ground floor level is used for vehicular parking while the upper floors are for pure residential use.
- 2.2 Following are prohibited uses for the ground level of these dwellings:
 - 2.2.1 Large scale industrial use, any use where flammable materials are used, any use where public is disturbed from loud noises, smell or dust generating and carrying activities, constructing go downs.

3. BUILDING HEIGHT, F.S.I AND SETBACK PLAN

3.1 Building F.S.I is provided in the development drawings along with building setback and is calculated as:

$$\text{Floor Space Index (F.S.I)} = \frac{\text{Total covered area of the building}}{\text{Plot area}}$$

3.2 Following spaces will be excluded from GFA:

- Parking Area
- Basement Parking
- Terrace Communal Space
- Ramps dedicated for parking
- Open Void
- Lift Void
- Service Duct
- Stair Void of top floor

3.3 Maximum building height from pavement level is 24 meters, which excludes 4 m given for the lift machine room and the development of 50% of the terrace floor level. No other building structure should extend beyond this height limit (refer to development guideline drawing for allowable height).

3.4 Minimum height between each floor is to be of 3.0 meters with finished floor levels to slab soffit in any habitable space should be of minimum 2.7 meters.

3.5 Building components such as balcony, gutter, eaves, etc., can only be projected out 80% of the front length of the building into 1 meter front setback from 3.0 meter above the ground level. Such spaces can be used as balconies or habitable parts of the building.

3.6 Setbacks should be clear of any construction at ground floor level and should not be shaded and used for any purposes.

3.7 The roof slab can be projected onto the front setback, it should conform to 3.4 of this guidelines.

3.8 The roof slab (terrace slab) or any part of the staircase and lift machine room should not be projected onto the side or rear setbac



4. BOUNDARY WALL

- 4.1 Urban interaction is highly encouraged at street level to provide seamless integration of private and public space but without compromising privacy and security.
- 4.2 If required the developer may choose to have a boundary wall with perforation or demarcate the plot boundary with a natural green verge or solid wall of maximum 1.2 meters. Boundary walls on the side and rear can be built to a maximum height of 2m and should be built inside the given boundary line.

5. ACCESS AND CIRCULATION

5.1 PEDESTRIAN

- 5.1.1 The layout of the scheme should provide safe and convenient pedestrian access to all dwellings and to facilities and services within the plot.
- 5.1.2 Accessibility provision with ease of circulation should be provided as much as possible to all type of users particularly the elderly and physically impaired.
- 5.1.3 If shared pathways (for vehicles and pedestrians) are to be provided within the development, appropriate markings should be used to indicate pedestrian prominence over vehicles.



6. GENERAL REQUIREMENTS

- 6.1 Ground floor level should accommodate vehicular parking, lobby/waiting area and also a service area for panel room, pump room, utilities which is easily accessible by service providers.
- 6.2 Waste disposal mechanism with ease of loading should be established separately within the development at the ground level.
- 6.3 A minimum of 1 staircase and 1 lift should be provided within the common area of the building. Staircase should be designed to cater for emergency evacuation as well.
- 6.4 Lift lobbies, corridors and ventilation voids should be designed to allow maximum natural light and ventilation.

7. PARKING

- 7.1 Parking spaces should be designed to an international standard (standard referred should be mentioned).
- 7.2 Ground floor of the development is to be dedicated for parking.
- 7.3 Parking spaces should be appropriately sized for movement in and around and should cater for disability and wheelchair movement where considered necessary.
- 7.4 The entrance for the parking area should have a sufficient opening for easy entry and exit simultaneously.
- 7.5 Motorbike parking shall be provided as per the following.
 - 7.5.1 1 motorbike from each 1- and 2-bedroom apartment
 - 7.5.2 2 motorbikes for each 3 bedroom apartment and above.
 - 7.5.3 An additional 10% of the total number of parking must be allocated for visitors parking.
 - 7.5.4 3-5 % of total number of motorbike parking slots must be designed for people with disability (PWD)



8.SERVICES

- 8.1 It is recommended that consultation be done with services providers of electrical, plumbing, sewerage, telecommunications and cable TV, as to how these could be incorporated to the building design. Developer has to provide provision for space within the development.
- 8.2 Any space required by the relevant service provider for the installation or provision of a supporting facility (transformer, pump rooms, storage tanks, service stations etc.) should be provided well within the given area for the development.
- 8.3 Every dwelling should be connected to the electricity and telephone networks and provided with TV signal via cable, where such services are available or provisions made to facilitate the installation when required.
- 8.4 Every dwelling should be provided with an adequate supply of water for drinking, culinary use and other general domestic purposes.
- 8.5 The water quality should comply with the standards set down by the Health Protection Agency (HPA) if proposed to use a private water supply.
- 8.6 An approved firefighting layout for the development should be obtained from Maldives National Defense Force (MNDF) Fire and Rescue Services Department.
- 8.7 Discharge of foul water should be to a public sewer or to an approved group sewerage scheme.
- 8.8 The layout of each utility should generally be in accordance with the established practice of the local authority and, as far as practicable, should accord with the preferences of the relevant utilities providers.



9.PRIVATE OPEN SPACES

- 9.1 So far as practicable, all dwellings should be provided with private open space, preferably adjacent to the main living area.
- 9.2 The private open space can be used as or together with a drying area which may be screened from public view.

10.RESIDENTIAL UNITS / DWELLING

- 10.1 Consideration must be given to ease of access and circulation within the dwelling especially for all occupants especially for the physically impaired.
- 10.2 The pedestrian approach towards the entrance of dwellings should be wide enough for two way traffic with the main entrance of the dwelling at least 900mm wide and provided with adequate lighting.
- 10.3 Where stepped access is unavoidable especially at ground floor level, the steps should be designed as suitable for physically impaired persons or wheelchair users.
- 10.4 Design and layout should make use of natural daylight and sunlight as much as possible to encourage minimum use of electrical lights during daytime.
- 10.5 Opening section of windows, above ground floor level, should be at a minimum height of 1000mm above internal floor finish level.
- 10.6 Glazing used for doors and windows should be safe and with a nominal thickness of 6mm or greater.
- 10.7 Where ever a railing is provided, it should be safe for all occupants, especially for children, with a maximum distance of 125mm openings between the railing members where applicable. Horizontal railings, which allow for children to climb it easily is not allowed, but in the case that horizontal railings are proposed, it should be used with a protective backing which disallows it to be climbed on.
- 10.8 Floor finishes in areas likely to get wet should be provided with slip resistant surfaces.
- 10.9 The minimum width of the internal residential corridors should be of 1.0 meter.
- 10.10 Maximum number of apartment should not exceed more than 14 apartments.
- 10.11 Every bedroom should have en suite bathroom. All bathrooms must have minimum 4ft width with a total area of minimum 24sqft.
- 10.12 Natural ventilation for every habitable space should be provided as follows:



11. PRIVATE OPEN SPACES

- 11.1 So far as practicable, all dwellings should be provided with private open space, preferably adjacent to the main living area.
- 11.2 The private open space can be used as or together with a drying area which may be screened from public view.

12. RESIDENTIAL UNITS / DWELLING

- 12.1 Consideration must be given to ease of access and circulation within the dwelling especially for all occupants especially for the physically impaired.
- 12.2 The pedestrian approach towards the entrance of dwellings should be wide enough for two way traffic with the main entrance of the dwelling at least 900mm wide and provided with adequate lighting.
- 12.3 Where stepped access is unavoidable especially at ground floor level, the steps should be designed as suitable for physically impaired persons or wheelchair users.
- 12.4 Design and layout should make use of natural daylight and sunlight as much as possible to encourage minimum use of electrical lights during daytime.
- 12.5 Opening section of windows, above ground floor level, should be at a minimum height of 1000mm above internal floor finish level.
- 12.6 Glazing used for doors and windows should be safe and with a nominal thickness of 6mm or greater.
- 12.7 Where ever a railing is provided, it should be safe for all occupants, especially for children, with a maximum distance of 125mm openings between the railing members where applicable. Horizontal railings, which allow for children to climb it easily is not allowed, but in the case that it horizontal railings are proposed, it should be used with a protective backing which disallows it to be climbed on.
- 12.8 Floor finishes in areas likely to get wet should be provided with slip resistant surfaces.
- 12.9 The minimum width of the internal residential corridors should be of 1.0 meter.
- 12.10 Maximum number of apartment should not exceed more than 14 apartments.
- 12.11 Every bedroom should have en suite bathroom. All bathrooms must have minimum 4ft width with a total area of minimum 24sqft.
- 12.12 Natural ventilation for every habitable space should be provided as follows:



- Floor area covering a radius of 6000mm from a window opening should cater 10% ventilation of the floor area.
- Floor area covering a radius of 7500mm from a window opening should cater 15% ventilation of the floor area.

12.13 A terrace can be developed, whereby the terrace can be used by the residents to carry out special events or a roof garden as a communal space. The covered area of the terrace can be developed as a gym, multipurpose hall or alike to that which can be used by the residents. The covered area on terrace should be 50% of the building area which includes the stair and the lift machine room. The enclosed area should be as one entity and should not be separated. No structural member (column and beam) should extend beyond it.

12.14 The covered terrace area should be able to accommodate solar panels to be used to in the production of renewable energy in Hulhumalé.

12.15 Any balcony railing to be constructed should have a height of 1.2m from the finished floor level.

12.16 Any balcony to be constructed on the periphery of a plot, a privacy panel of at least 2m height should be fixed on the peripheral side abutting the adjacent plot. This privacy panel should have the following characteristics:-

- Privacy panel should be such that it provides uninterrupted air flow through it
- Privacy panel should be such that adjacent houses cannot be viewed through it

12.17 A safe, parapet wall or railing of 1.2m in height should be constructed surrounding the perimeter of the terrace slab.

12.18 If a parapet wall is constructed on the periphery abutting the adjacent plot then it should have a height of 2m.

12.19 Any door/window at the ground floor of the building when opened or closed should not extend beyond the boundary line. If a window is being opened towards the road, a sufficient setback should be given to open the door.

12.20 Window panels that project outside the building when opened or closed can only be fixed above 3m from the ground level. These panels can be projected to a maximum of 750mm beyond the building wall.



12.21 Frosted windows (fixed and not openable) or glass blocks of similar nature which provides visual privacy to the neighbor are allowed on the peripheral wall abutting the adjacent lot.

13. DEPTH OF FOUNDATION

13.1 Depth of foundation for each building would be determined by the structural engineer of the development.

13.2 Foundation protection method and visual soil report should be submitted.

13.3 If the foundation of the structure is 1.8m or deeper, developer should submit environmental impact assessment.

NOTE: In addition to this, please refer to the accompanying guideline drawings.

